



Proj. # 21507.02 A1001 PERMIT SET JONATHAN D. MOODY, LIC. #1215709

D. MOODY

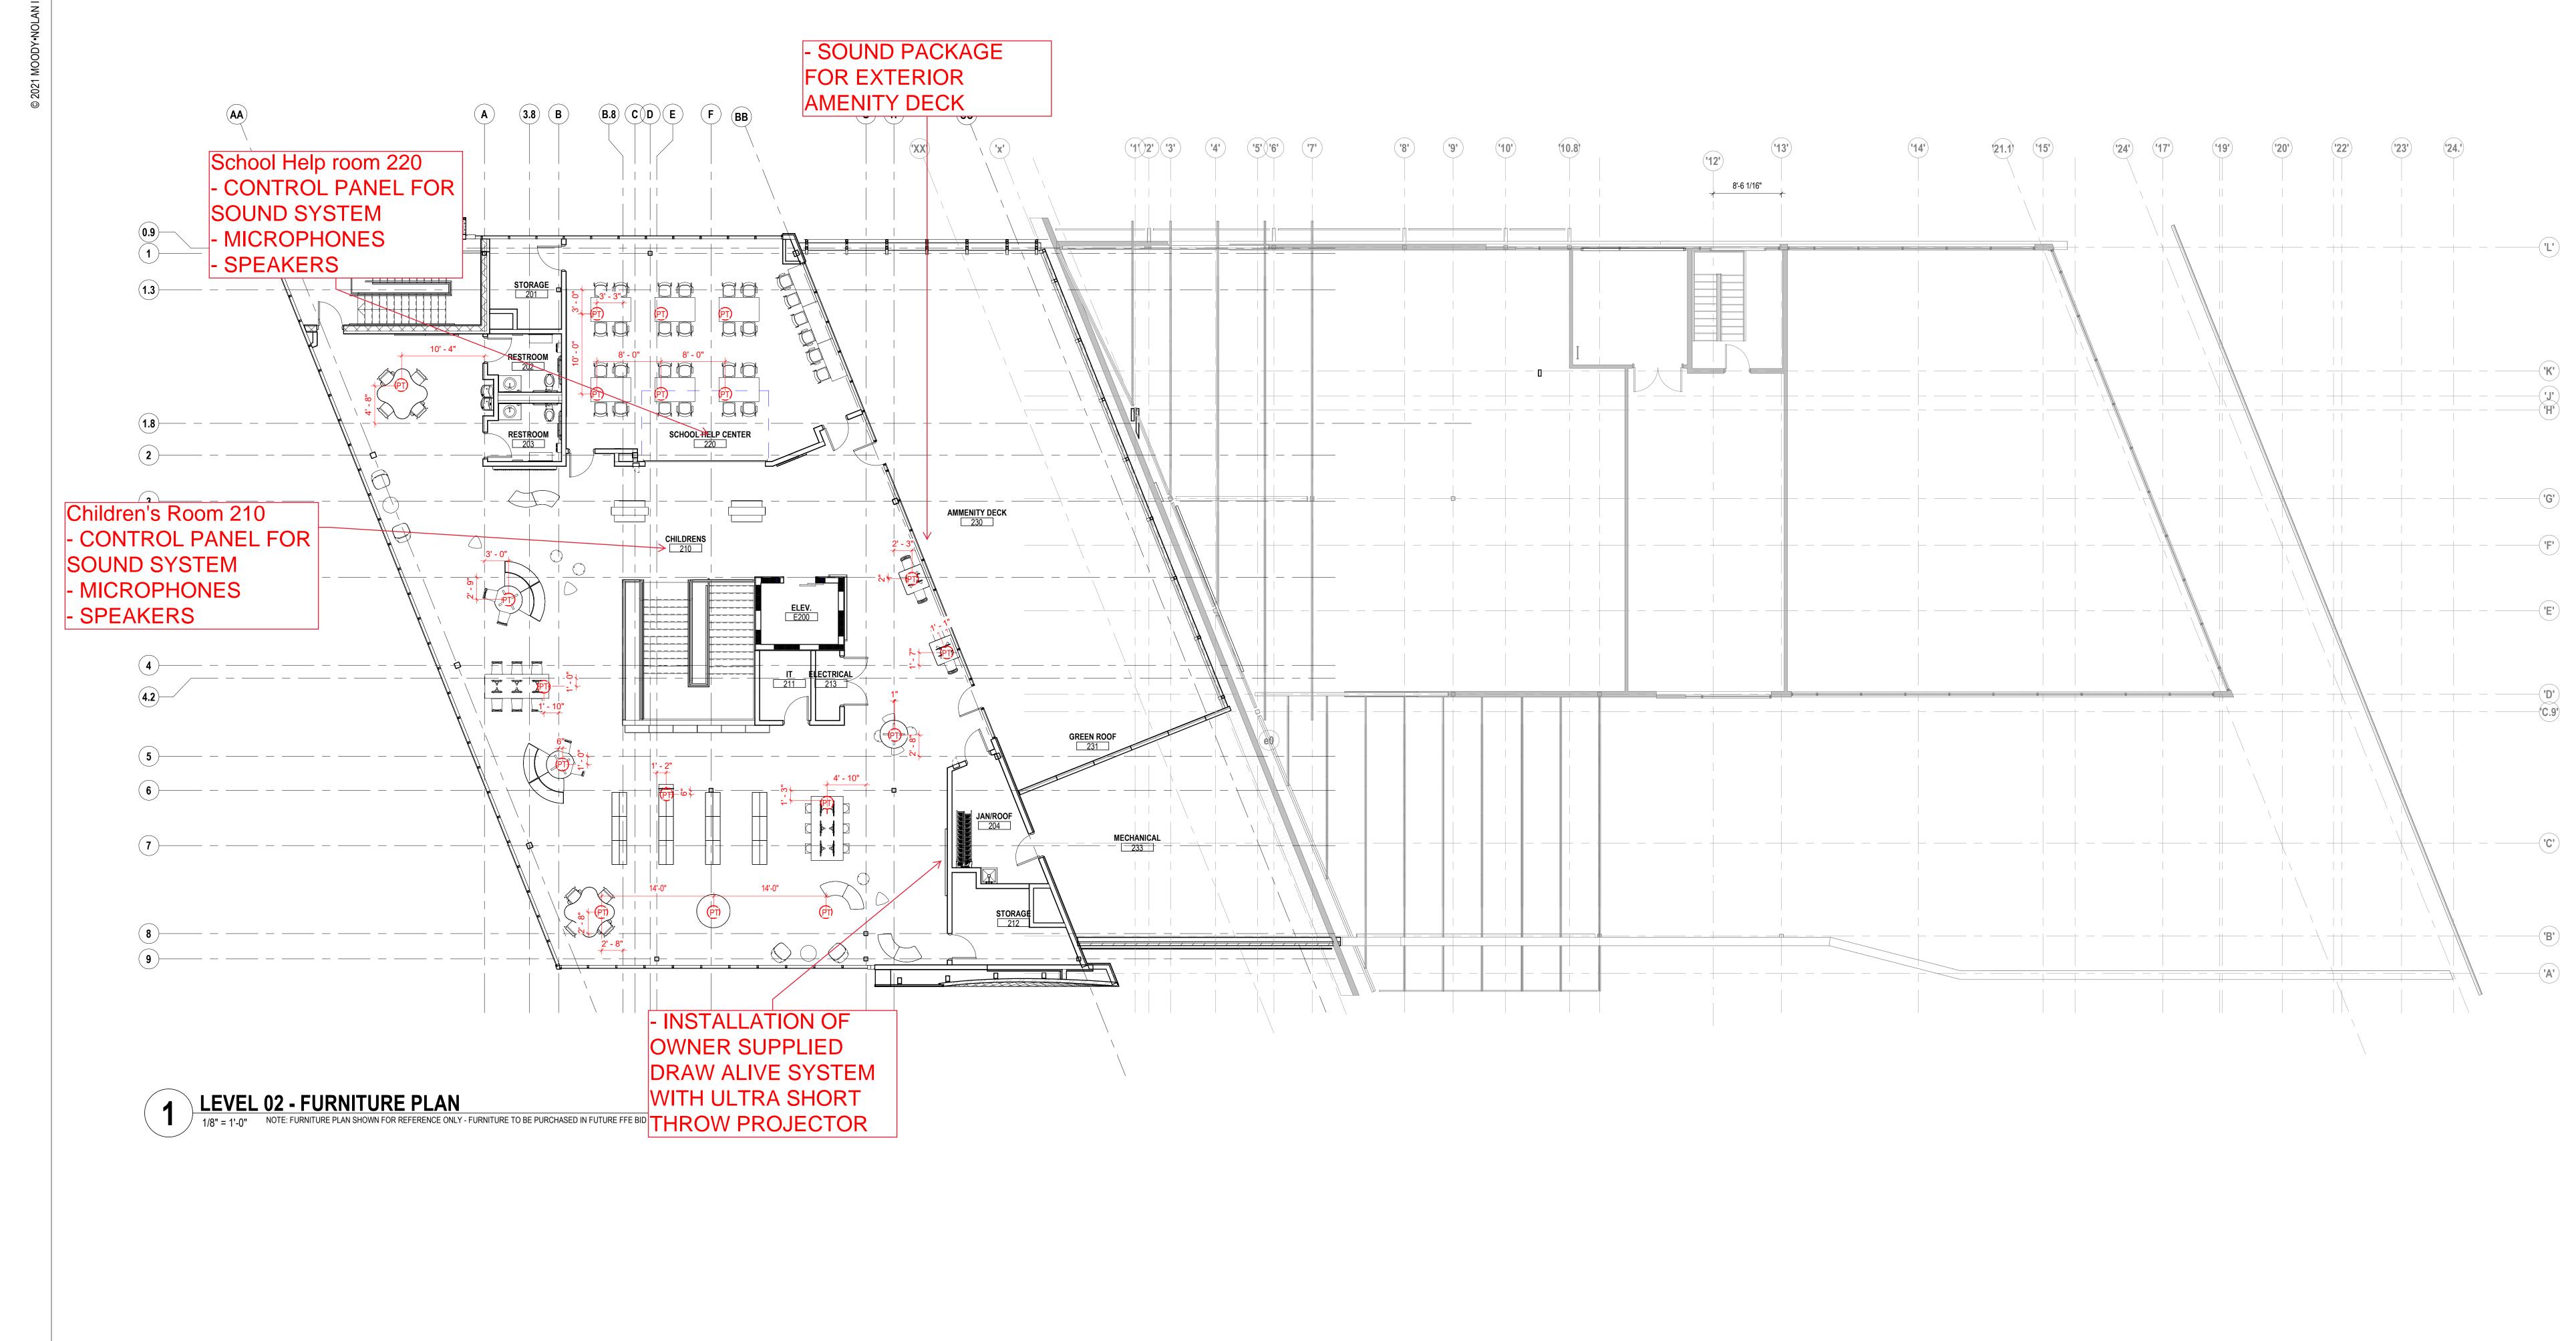

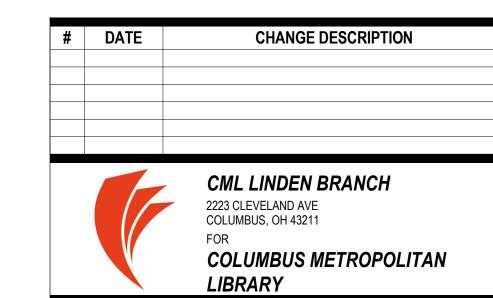




300 SPRUCE STREET SUITE 300 COLUMBUS, OHIO 43215

PHONE: (614) 461-4664 FAX: (614) 280-8881

LEVEL 02 - FURNITURE PLAN

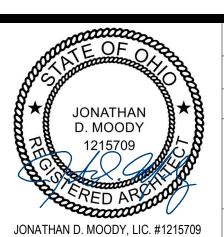

NOVEMBER 21, 2023 Proj. # 21507.02

> A1002 PERMIT SET


WP WEATHERPROOF

	TELECOM SYMBOLS	TELECOM REQUIREMENTS	PATHWAY REQUIREMENTS
ΔM	SINGLE-PORT WALL DATA OUTLET MOUNTED AT 44" AFF, UNO.	SINGLE GANG, ONE-PORT FACEPLATE. PROVIDE ONE CAT6 CABLE, TERMINATED ON PATCH PANEL IN TELECOM ROOM.	4-11/16" SQUARE, 2-1/8" DEEP BOX WITH A SINGLE GANG PLASTER RING AND 1" CONDUIT INSTALLED TO ABOVE ACCESSIBLE CEILING, CABLE TRAY OR TELECOM ROOM.
▼	WORKSTATION WALL OUTLET MOUNTED AT 18"AFF, UNO.	SINGLE GANG, TWO-PORT FACEPLATE. PROVIDE TWO CAT6 CABLES, TERMINATED ON PATCH PANEL IN TELECOM ROOM.	4-11/16" SQUARE, 2-1/8" DEEP BOX WITH A SINGLE GANG PLASTER RING AND 1" CONDUIT INSTALLED TO ABOVE ACCESSIBLE CEILING, CABLE TRAY OR TELECOM ROOM.
FBX	RECESSED WORKSTATION FLOOR OUTLET.	SINGLE GANG, SIX-PORT FACEPLATE. 'X' SUB-SCRIP = NUMBER OF DATA PORTS. PROVIDE SAME NUMBER OF CAT6 CABLES AS SUP-SCRIP NUMBER, TERMINATED ON PATCH PANEL IN TELECOM ROOM.	MULTI-SERVICE POWER/DATA FLOOR BOX. (1) 1" CONDUIT FOR POWER AND (1) 1" FOR DATA FROM BOX TO ABOVE ACCESSIBLE CEILING, CABLE TRAY OR TELECOM ROOM. SEE DIVISION 26 FOR BOX INFORMATION.
▼ H	WORKSTATION WALL OUTLET WITH (1) HDMI JACK AND (1) DATA PORT , MOUNTED AT 18"AFF, UNO.	SINGLE GANG FACEPLATE. PROVIDE SINGLE HDMI FEMALE PORT AND ONE DATA PORT. PROVIDE (1) HDMI CABLE FROM WORKSTATION WALL OUTLET TO LOCAL TV OUTLET. PROVIDE (1) CAT6 CABLE TO TR PATCH PANEL.	4-11/16" SQUARE, 2-1/8" DEEP BOX WITH A SINGLE GANG PLASTER RING. (1) 1" AND (1) 1-1/2" CONDUIT INSTALLED TO ABOVE ACCESSIBLE CEILING.
TV	WALL-MOUNTED TV OUTLET WITH (1) DATA AND (1) HDMI JACK. OUTLET MOUNTED AT 60" AFF, UON.	PROVIDE ONE CAT6 CABLE FROM TV OUTLET TO TELECOM ROOM PATCH PANEL. EXTEND AND TERMINATE HDMI CABLE FROM FLOOR OUTLET OR WORKSTATION OUTLET. SEE SPECIFICATION FOR WHEN SHIELDED CAT6 IS REQUIRED FOR HDMI EXTENSION.	4-11/16" SQUARE, 2-1/8" DEEP BOX WITH A SINGLE GANG PLASTER RING. (1) 1" CONDUIT INSTALLED TO ABOVE ACCESSIBLE CEILING AND (1) 1-1/4" CONDUIT INSTALLED TO ABOVE ACCESSIBLE CEILING OR TO FLOOR BOX.
.	DATA OUTLET FOR WIRELESS ACCESS POINT, CEILING MOUNTED. W = WALL MOUNTED.	PROVIDE ONE CAT6A CABLE, TO CAT6A PATCH PANEL IN TR. PROVIDE EXTRA 20' COIL OF CABLE AND ONE 12-INCH PATCH CORD AT FINAL WAP LOCATION.	4-11/16" SQUARE, 2.125" DEEP BOX WITH A 3" ROUND PLASTER RING MOUNTED FLUSH TO THE CEILING.
(SP)	SOUND REINFORCEMENT SPEAKER, FLUSH MOUNTED.	ROUGH-IN ONLY, OWNER PROVIDING DEVICE AND CABLING.	4-11/16" SQUARE, 2.125" DEEP BOX.3/4"C TO NEXT SPEAKER, TO CABLE TRAY OR TO A/V EQUIPMENT CABINET.
SP	SOUND REINFORCEMENT SPEAKER, SUFACE MOUNTED.	ROUGH-IN ONLY, OWNER PROVIDING DEVICE AND CABLING.	4-11/16" SQUARE, 2.125" DEEP BOX.3/4"C TO NEW, SPEAKER OR TO A/V EQUIPMENT CABINET.
PA	PA SPEAKER, SURFACE MOUNTED.	PROVIDE SPEAKER AND CABLING PER SPECIFICATION.	4-11/16" SQUARE, 2.125" DEEP BOX.3/4"C TO NEXT SPEAKER, TO CABLE TRAY OR TO TELECOM ROOM.
PA	PA SPEAKER, FLUSH MOUNTED.	PROVIDE SPEAKER AND CABLING PER SPECIFICATION.	4-11/16" SQUARE, 2.125" DEEP BOX.3/4"C TO NEXT SPEAKER, TO CABLE TRAY OR TO TELECOM ROOM.
•	RECESSED CEILING MOUNTED DATA OUTLET.	PROVIDE ONE CAT6 CABLE, TERMINATED ON CAT6 JACK IN PATCH PANEL AND INSIDE DATA OUTLET. PROVIDE EXTRA 10' COIL OF CABLE AND ONE 12-INCH PATCH CORD AT FINAL DEVICE LOCATION.	4-11/16" SQUARE, 2.125" DEEP BOX WITH A 3" ROUND PLASTER RING MOUNTED FLUSH TO THE CEILING.
V	VOLUME CONTROL FOR PAGING SYSTEM, MOUNTED AT 48" AFF, UON.	PROVIDE VOLUME CONTROL AND CABLING PER SPECIFICATION.	4-11/16" SQUARE, 2.125" DEEP BOX WITH A SINGLE GANG PLASTER RING. 3/4" C TO ABOVE ACCESSIBLE CEILING, CABLE TRAY, OR TELECOM ROOM.

NOTE: NOT ALL SYMBOLS MAY BE USED.

SECURITY SYMBOLS	PATHWAY REQUIREMENT
VIDEO SURVEILLANCE CAMERA, OWNER PROVIDED C= CEILING MOUNTED '180' = DUAL LENS CAMERA '360' = QUAD LENS CAMERA 'D' = DOME LENS CAMERA 2	4-11/16" SQUARE, 2-1/8" DEEP BOX WITH A SINGLE GANG PLASTER RING AND 3/4" CONDUIT INSTALLED TO ABOVE ACCESSIBLE CEILING. PROVIDE CAMERA, CAT6 CABLE AND "BISCUIT" OUTLET.
ALARM HORN, OWNER PROVIDED	4-11/16" SQUARE, 2-1/8" DEEP BOX WITH A SINGLE GANG PLASTER RING AND 3/4" CONDUIT INSTALLED TO ABOVE ACCESSIBLE CEILING.
CR CARD READER, OWNER PROVIDED	4-11/16" SQUARE, 2-1/8" DEEP BOX WITH A SINGLE GANG PLASTER RING AND 3/4" CONDUIT INSTALLED TO ABOVE ACCESSIBLE CEILING 48" AFF. 'KP' = WITH KEYPAD
DO DOOR CONTACT, OWNER PROVIDED	4-11/16" SQUARE, 2-1/8" DEEP BOX WITH A SINGLE GANG PLASTER RING AND 3/4" CONDUIT INSTALLED TO ABOVE ACCESSIBLE CEILING.
GB GLASS BREAK SENSOR, OWNER PROVIDED	4-11/16" SQUARE, 2-1/8" DEEP BOX WITH A SINGLE GANG PLASTER RING AND 3/4" CONDUIT INSTALLED TO ABOVE ACCESSIBLE CEILING.
MOTION DETECTOR, OWNER PROVIDED	4-11/16" SQUARE, 2-1/8" DEEP BOX WITH A SINGLE GANG PLASTER RING AND 3/4" CONDUIT INSTALLED TO ABOVE ACCESSIBLE CEILING.
CCTV MONITOR STATION, OWNER PROVIDED	4-11/16" SQUARE, 2-1/8" DEEP BOX WITH A SINGLE GANG PLASTER RING AND 3/4" CONDUIT INSTALLED TO ABOVE ACCESSIBLE CEILING
PUSH BUTTON - PANIC, OWNER PROVIDED	4-11/16" SQUARE, 2-1/8" DEEP BOX WITH A SINGLE GANG PLASTER RING AND 3/4" CONDUIT INSTALLED TO ABOVE ACCESSIBLE CEILING COORDINATE LOCATIONS WITH ARCHITECT PRIOR TO ROUGH-IN.
PUSH BUTTON - LOCK DOWN, OWNER PROVIDED	4-11/16" SQUARE, 2-1/8" DEEP BOX WITH A SINGLE GANG PLASTER RING AND 3/4" CONDUIT INSTALLED TO ABOVE ACCESSIBLE CEILING. COORDINATE LOCATIONS WITH ARCHITECT PRIOR TO ROUGH-IN.
INTERCOM - STATION, OWNER PROVIDED	4-11/16" SQUARE, 2-1/8" DEEP BOX WITH A SINGLE GANG PLASTER RING AND 1" CONDUIT INSTALLED TO TELECOM RACK.
D DOOR BELL, OWNER PROVIDED	4-11/16" SQUARE, 2-1/8" DEEP BOX WITH A SINGLE GANG PLASTER RING AND 1" CONDUIT INSTALLED TO DOOR CHIME
DOOR BELL CHIME, OWNER PROVIDED	4-11/16" SQUARE, 2-1/8" DEEP BOX WITH A SINGLE GANG PLASTER RING AND 1" CONDUIT INSTALLED TO DOOR BELL

SECURITY KEYNOTES: A. PROVIDE CAT6 CABLE FROM CARD READER TO NEAREST ER/TR AND LEAVE WITH A 10' SERVICE LOOP COILED AT THE BACKBOARD SPACE RESERVED FOR THE OWNERS PROVIDED CONTROL UNITS. B. CONTRACTOR SHALL PLAN FOR ONE PRE-INSTALLATION MEETING WITH OWNER, DOOR HARDWARE SUPPLIER, SECURITY CONTRACTOR, AND ARCHITECT TO REVIEW LOCATIONS AND INSTALLATION
REQUIREMENTS. C. ALL SECURITY DEVICES SHOWN ON FLOOR PLANS AND SYMBOLS ABOVE SHALL BE ROUGH-INS AND PATHWAYS ONLY, WITH DEVICES PROVIDED BY CML'S SECURITY VENDOR. CONTRACTOR SHALL VERIFY EXACT ROUGH-IN AND PATHWAY REQUIREMENTS WITH CML'S SECURITY

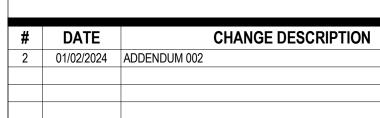



CML LINDEN BRANCH COLUMBUS, OH 43211 COLUMBUS METROPOLITAN LIBRARY



300 SPRUCE STREET SUITE 300 COLUMBUS, OHIO 43215

PHONE: (614) 461-4664 FAX: (614) 280-8881

GENERAL INFORMATION -TELECOMMUNICATIONS

11/20/2023 **Bicsi**


11/21/2023 DRAWN BY: Author CHECKED BY: Checker Proj. # 21507

PERMIT SET

T001

QUIET ROOM STUDY RM OVERHEAD CANOPY **OVERHEAD CANOPY**

PLAN MAIN LEVEL PLAN - TELECOMMUNICATIONS

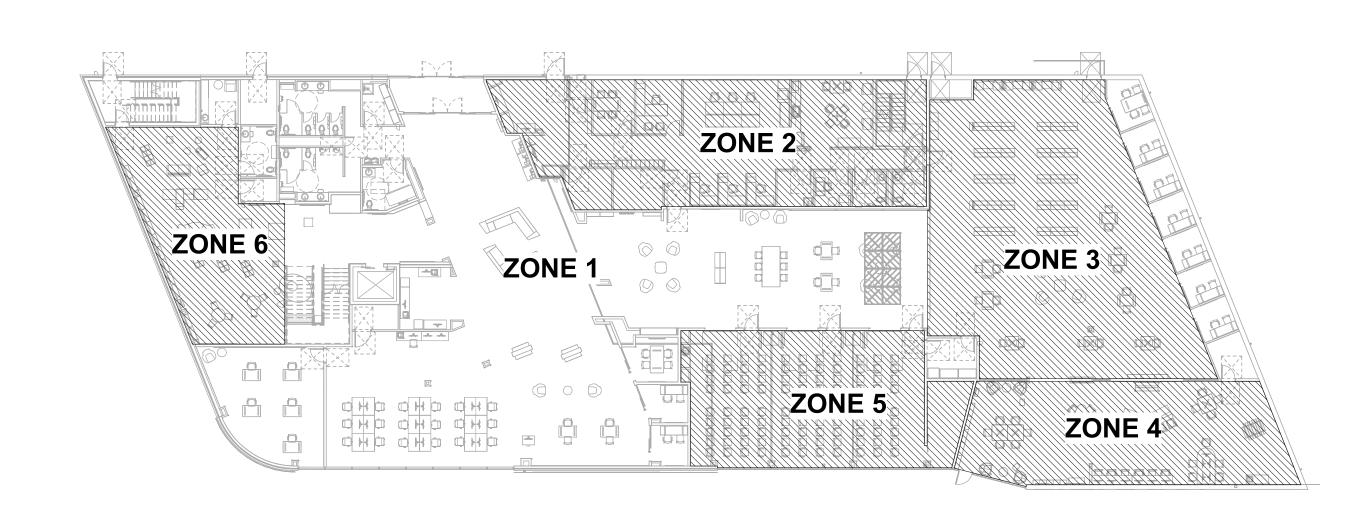

PLAN MAIN LEVEL PLAN - P/A PAGING ZONES 3/64" = 1'-0" REFER TO SHEET T701, DETAIL 4

SHEET KEYNOTES

- 4-GANG FLOOR BOX FOR POWER AND DATA. PROVIDE THE SAME NUMBER OF CAT6 CABLES AND PORTS AS INDICATED BY THE SUB-SCRIPT. REFER TO ELECTRICAL DRAWINGS FOR MORE INFORMATION ABOUT FLOOR BOX.
- PROVIDE SINGLE PORT DATA OUTLET MOUNT HORIZONTALLY AT 42" AFF FOR ROOM SCHEDULING TABLET MOUNTED AT 42". COORDINATE WITH ARCHITECT AND OWNER PRIOR TO ROUGH IN.
- PROVIDE FLUSH MOUNTED JUNCTION BOX AT 18" AFF FOR DATA CABLING TO SYSTEMS FURNITURE. ROUTE CABLING TO SYSTEMS FURNITURE. ROUTE CABLING FROM WALL, THROUGH SYSTEM FURNITURE AND TERMINATE AT DATA OUTLETS INTEGRAL TO THE FURNITURE. ONE DATA PORT PER WORKSTATION.
- 4. 12" W X 4" D WIRE MESH CABLE TRAY MOUNTED AT 10'-6" AFF.
- PROVIDE CONDUITS ROUTED FROM CABLE TRAY TO ABOVE INACCESSIBLE CEILINGS IN QUANTITIES REQUIRED TO SERVE DATA OUTLETS AND DEVICES. PROVIDE ACCESS PANELS AS REQUIRED FOR COMPLETE INSTALLATION, COORDINATE FINISH WITH ARCHITECT.
- PROVIDE (3) 4" CONDUIT SLEEVES FOR HORIZONTAL CABLING THROUGH WALL.
- (2) 4" CONDUITS FOR BACKBONE CABLING FROM IT ROOM 132 TO IT ROOM 211 MOUNTED AT 10'-6" AFF, THEN STUB UP INTO THE SECOND FLOOR.
- PROVIDER PRIOR TO ROUGH-IN. PROVIDE DATA OUTLET FOR BAS CONTROL PANEL. COORDINATION EXACT REQUIREMENTS WITH

PROVIDE DATA OUTLET FOR FACP. COORDINATE EXACT REQUIREMENTS WITH FIRE ALARM

- HVAC CONTROLS CONTRACTOR.
- PROVIDE WEATHERPROOF OUTDOOR WAP MOUNTED AT 10' AFG.
- 11. PROVIDE DATA OUTLET FLUSH MOUNT IN CEILING FOR PEOPLE COUNTER SYSTEM. COORDINATE
- 12. EMERGENCY LOCK DOWN PUSH BUTTON MOUNTED UNDERNEATH THE COUNTER. LOCKDOWN

SYSTEM. COORDINATE EXACT REQUIREMENTS WITH OWNER PRIOR TO ROUGH-IN.


- 15. 12" W X 4" D WIRE MESH CABLE TRAY MOUNTED AT 13'-0" AFF.
- 16. PROVIDE SINGLE PORT DATA OUTLET FOR STAFF TIMECLOCK.
- 17. PROVIDE FLOOR BOX TO SERVE DEVICES LOCATED IN WELCOME SERVICE DESK CASEWORK. PROVIDE (1) 6-PORT DATA OUTLET IN FLOOR BOX WITH 10' PATCH CORD TO DEVICE LOCATIONS AND (1) PASS THROUGH OUTLET FOR SECURITY CABLING TO DEVICE LOCATIONS.


GENERAL SHEET NOTES

- COORDINATE ALL ROUGH-IN AND EQUIPMENT REQUIREMENTS OF DEVICES IN CASEWORK AND FURNITURE WITH ARCHITECTURAL SHEETS AND SPECIFICATIONS PRIOR TO ROUGH IN.

COORDINATE ALL A/V DEVICE LOCATIONS AND MOUNTING HEIGHTS WITH CML'S A/V VENDOR PRIOR

- COORDINATE FLOOR BOX LOCATIONS WITH ARCHITECTURAL FURNITURE AND ELECTRICAL POWER
- ALL DATA CABLES SHALL BE ROUTED IN CABLE TRAY, J-HOOKS, OR CONDUIT. CABLES SHALL BE ROUTED INCONSPICUOUSLY, PARALLEL TO BUILDING STRUCTURES AND DUCTWORK ETC.
- PROVIDE FIRE STOPPING AROUND ALL CONDUITS AND ALL TELECOMMUNICATIONS PENETRATIONS. ALL DATA CABLING SHALL BE HOMERUN TO IT 132.
- ALL SECURITY DEVICES SHOWN ARE ROUGH-IN AND PATHWAYS ONLY. SECURITY DEVICES SHALL BE

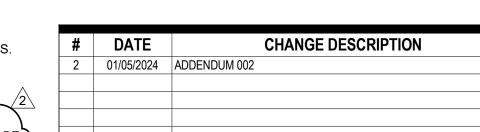

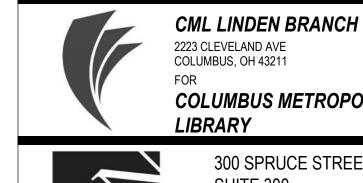

COLUMBUS, OH 43211 COLUMBUS METROPOLITAN LIBRARY 300 SPRUCE STREET




SUITE 300 COLUMBUS, OHIO 43215 PHONE: (614) 461-4664 FAX: (614) 280-8881

MAIN LEVEL PLAN -**TELECOMMUNICATIONS**

> 11/20/2023 Bicsi

11/21/2023 DRAWN BY: Author CHECKED BY: Checker Proj. # 21507

T101

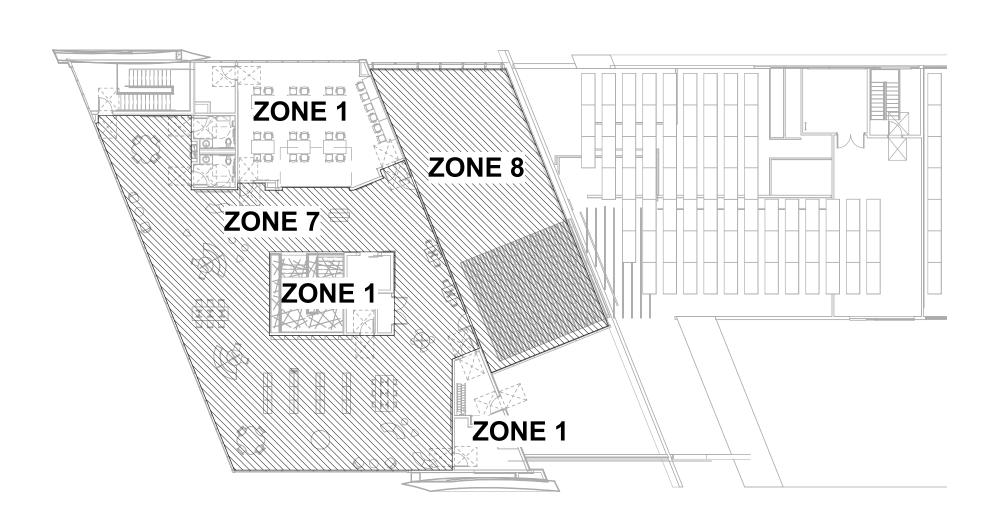

2 PLAN UPPER LEVEL PLAN - PAGING ZONE 3/64" = 1'-0" REFER TO SHEET T701, DETAIL 4

GENERAL SHEET NOTES

- COORDINATE ALL ROUGH-IN AND EQUIPMENT REQUIREMENTS OF DEVICES IN CASEWORK AND FURNITURE WITH ARCHITECTURAL SHEETS AND SPECIFICATIONS PRIOR TO ROUGH IN.
- 2. COORDINATE ALL A/V DEVICE LOCATIONS AND MOUNTING HEIGHTS WITH CML'S A/V VENDOR PRIOR TO ROUGH IN.
- 3. COORDINATE FLOOR BOX LOCATIONS WITH ARCHITECTURAL FURNITURE
- AND ELECTRICAL POWER SHEETS.

 4. ALL DATA CABLES SHALL BE ROUTED IN CONDUIT. CABLES SHALL BE ROUTED

INCONSPICUOUSLY, PARALLEL TO BUILDING STRUCTURES AND DUCTWORK

- 5. PROVIDE FIRE STOPPING AROUND ALL CONDUITS AND ALL TELECOMMUNICATIONS PENETRATIONS.
- 6. ALL DATA CABLING SHALL BE HOMERUN IN CONDUIT TO IT 211.

 7. ALL SECURITY DEVICES SHOWN ARE ROUGH-IN AND PATHWAYS ONLY. SECURITY DEVICES SHALL BE PROVIDED BY CML'S SECURITY VENDOR.

SHEET KEYNOTES

- 4-GANG FLOOR BOX FOR POWER AND DATA. PROVIDE THE SAME NUMBER OF CAT6 CABLES AND PORTS AS INDICATED BY THE SUB-SCRIPT. REFER TO ELECTRICAL DRAWINGS FOR MORE INFORMATION ABOUT FLOOR BOX.
 - PROVIDE DATA OUTLET FLUSH MOUNT IN CEILING FOR OWNER PROVIDED PROJECTOR. COORDINATE EXACT REQUIREMENTS WITH OWNER PRIOR TO ROUGH-IN.
- . (2) 4" CONDUITS FOR BACKBONE CABLING FROM THE FLOOR BELOW, STUB UP 8" INTO ROOM. REFER TO FIRST FLOOR TELECOMMUNICATION PLAN FOR CONTINUATION OF CONDUIT.
- PROVIDE SURFACE MOUNT ROUGH-IN UNDER AMENITY DECK SLANTED ROOF FOR OWNER PROVIDED SPEAKER. COORDINATE EXACT REQUIREMENTS WITH CML'S A/V VENDOR PRIOR TO ROUGH-IN..
- . WIRELESS PANIC BUTTON DEVICE ONTO MOBILE STAFF CART FOR THE ARE PROVIDED BY CML'S SECURITY VENDOR.
- PROVIDE DATA OUTLET POR BAS. COORDINATE WITH THE HIVAC CONTROL
 CONTRACTOR PRIOR TO ROUGH-IN FOR EXACT REQUIREMENTS.
- 8. PROVIDE FLUSH MOUNT ROUGH-IN, AT 12'-0" AFF FOR OWNER PROVIDED SPEAKER. COORDINATE EXACT REQUIREMENTS WITH CML'S A/V VENDOR PRIOR TO ROUGH-IN.
- PROVIDE SINGLE PORT DATA OUTLET MOUNTED HORIZONTALLY FOR ROOM SCHEDULING TABLET MOUNTED AT 42". COORDINATE WITH ARCHITECT AND OWNER PRIOR TO ROUGH IN.
- 10. PROVIDE DATA OUTLET FOR ELEVATOR CONTROLLER. COORDINATE EXACT REQUIREMENTS WITH ELEVATOR SUPPLIER PRIOR TO ROUGH-IN.
 11. PROVIDE DATA OUTLET FOR ELEVATOR PHONE. COORDINATE EXACT
- REQUIREMENTS WITH ELEVATOR SUPPLIER PRIOR TO ROUGH-IN.
- 12. PROVIDE SURFACE MOUNT WEATHERPROOF PA SPEAKER UNDER THE AMENITY DECK ROOF.
- 13. PROVIDE SURFACE MOUNT WEATHERPROOF PA SPEAKER AT 12'-0" AFF.



#	DATE	CHANGE DESCRIPTION
2	01/05/2024	ADDENDUM 002
CML LINDEN BRANCH		CML LINDEN BRANCH 2223 CLEVELAND AVE
		COLUMBUS, OH 43211
	V	COLUMBUS METROPOLITAN
		LIBRARY
		300 SPRUCE STREET
		SUITE 300 COLUMBUS, OHIO 43215
		00L0IVID00, 01110 40213
		PHONE: (614) 461-4664
		DLAN FAX: (614) 280-8881

UPPER LEVEL PLAN TELECOMMUNICATIONS

11/20/2023


Nicole E Reed


Nicole E Reed

11/21/2023

AWN BY: Author CHECKED BY: CHE




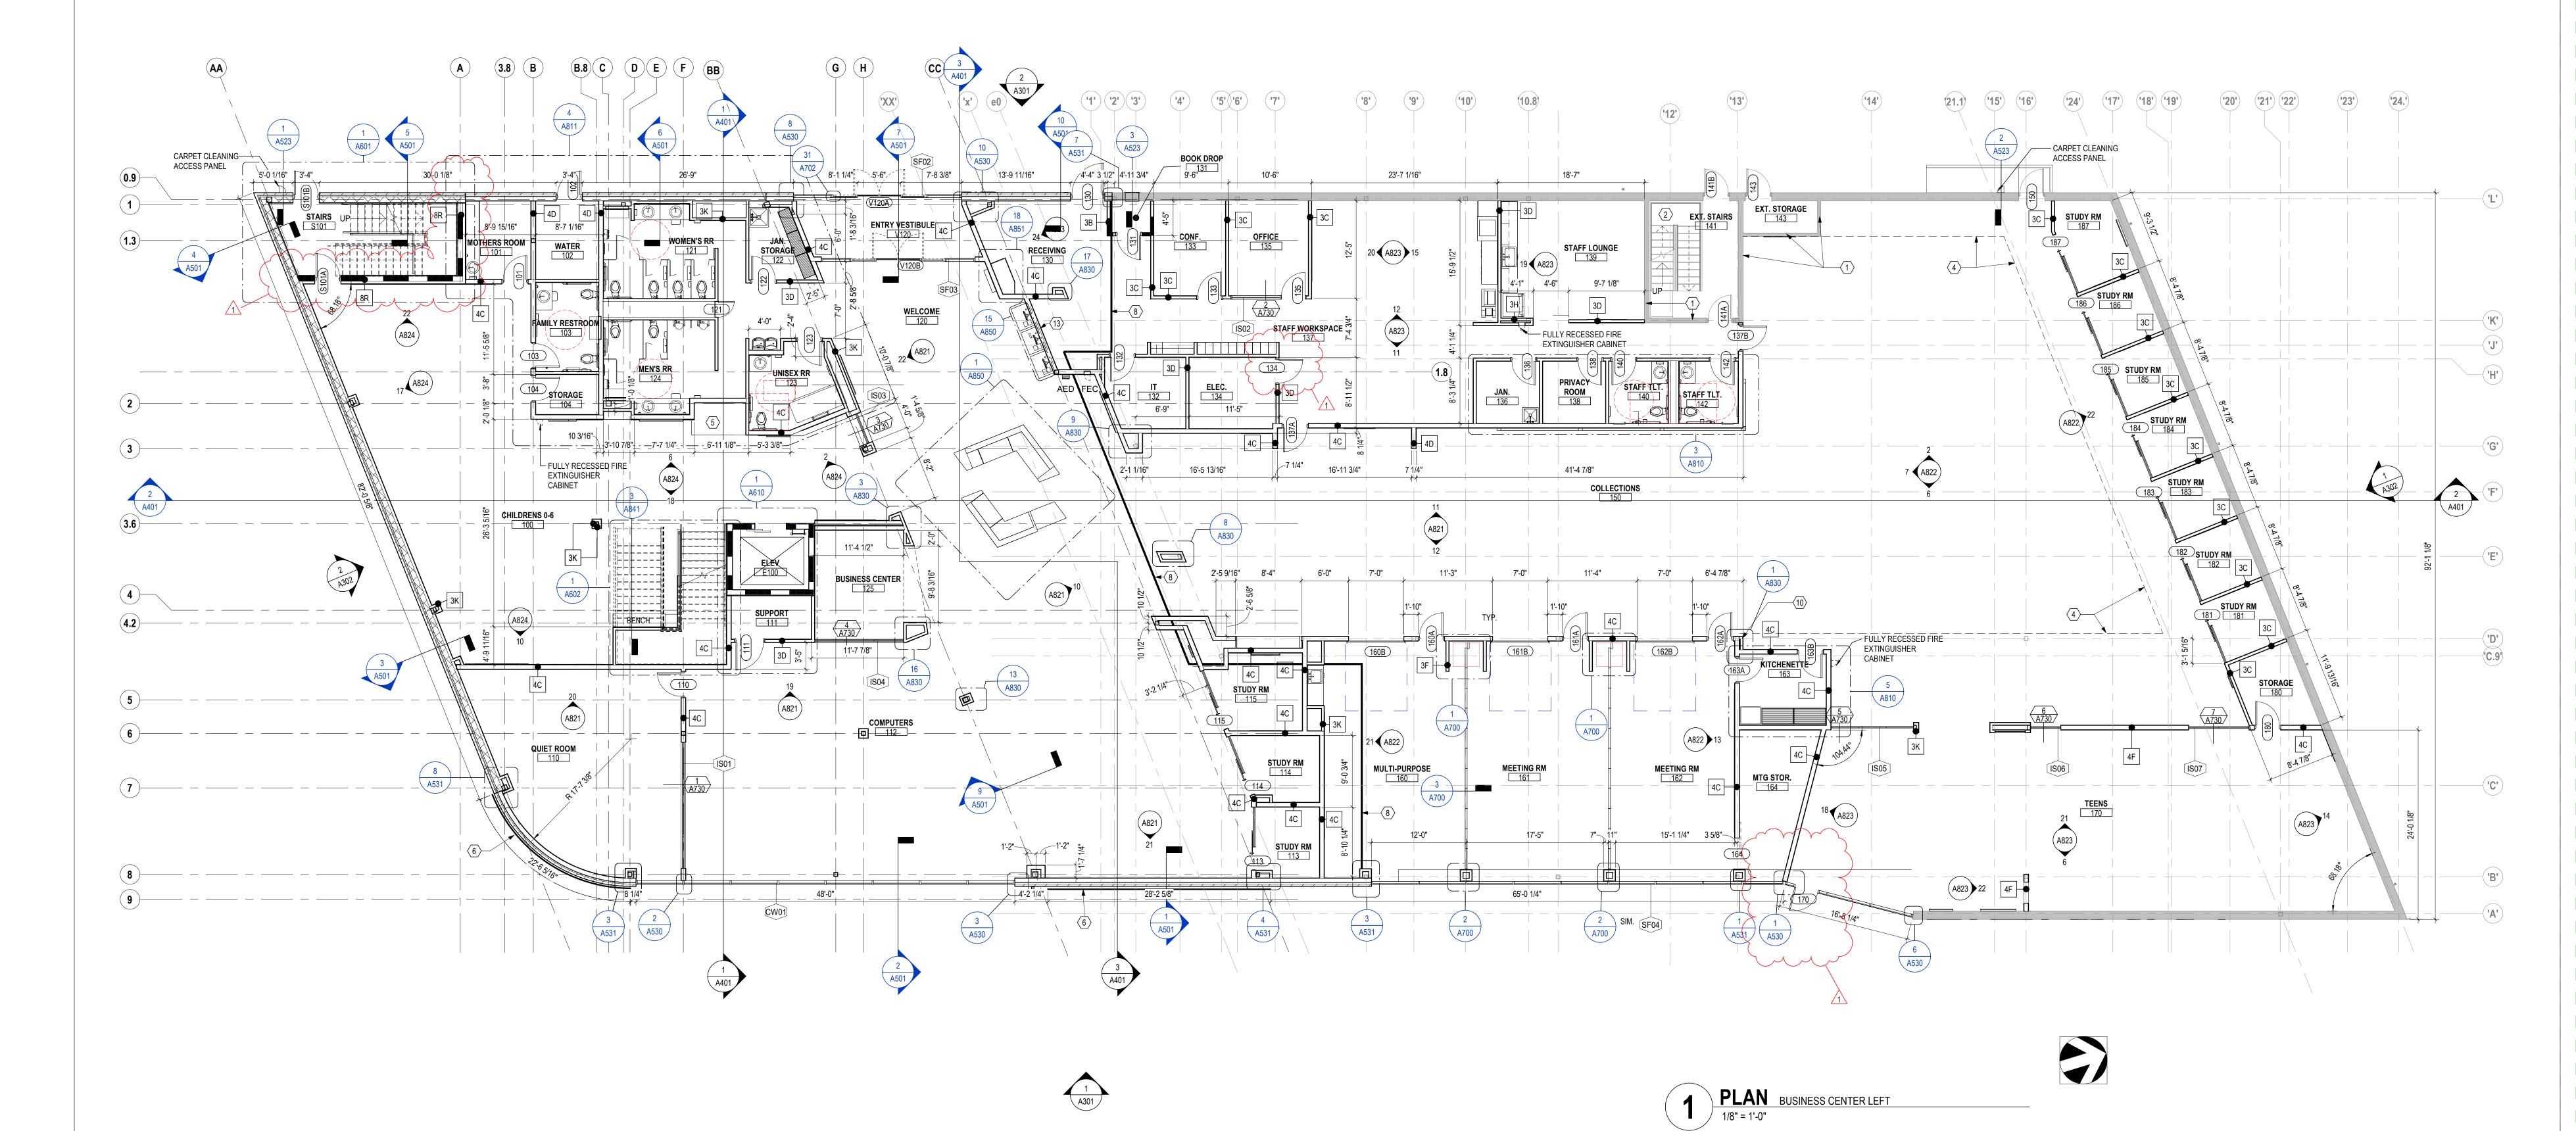

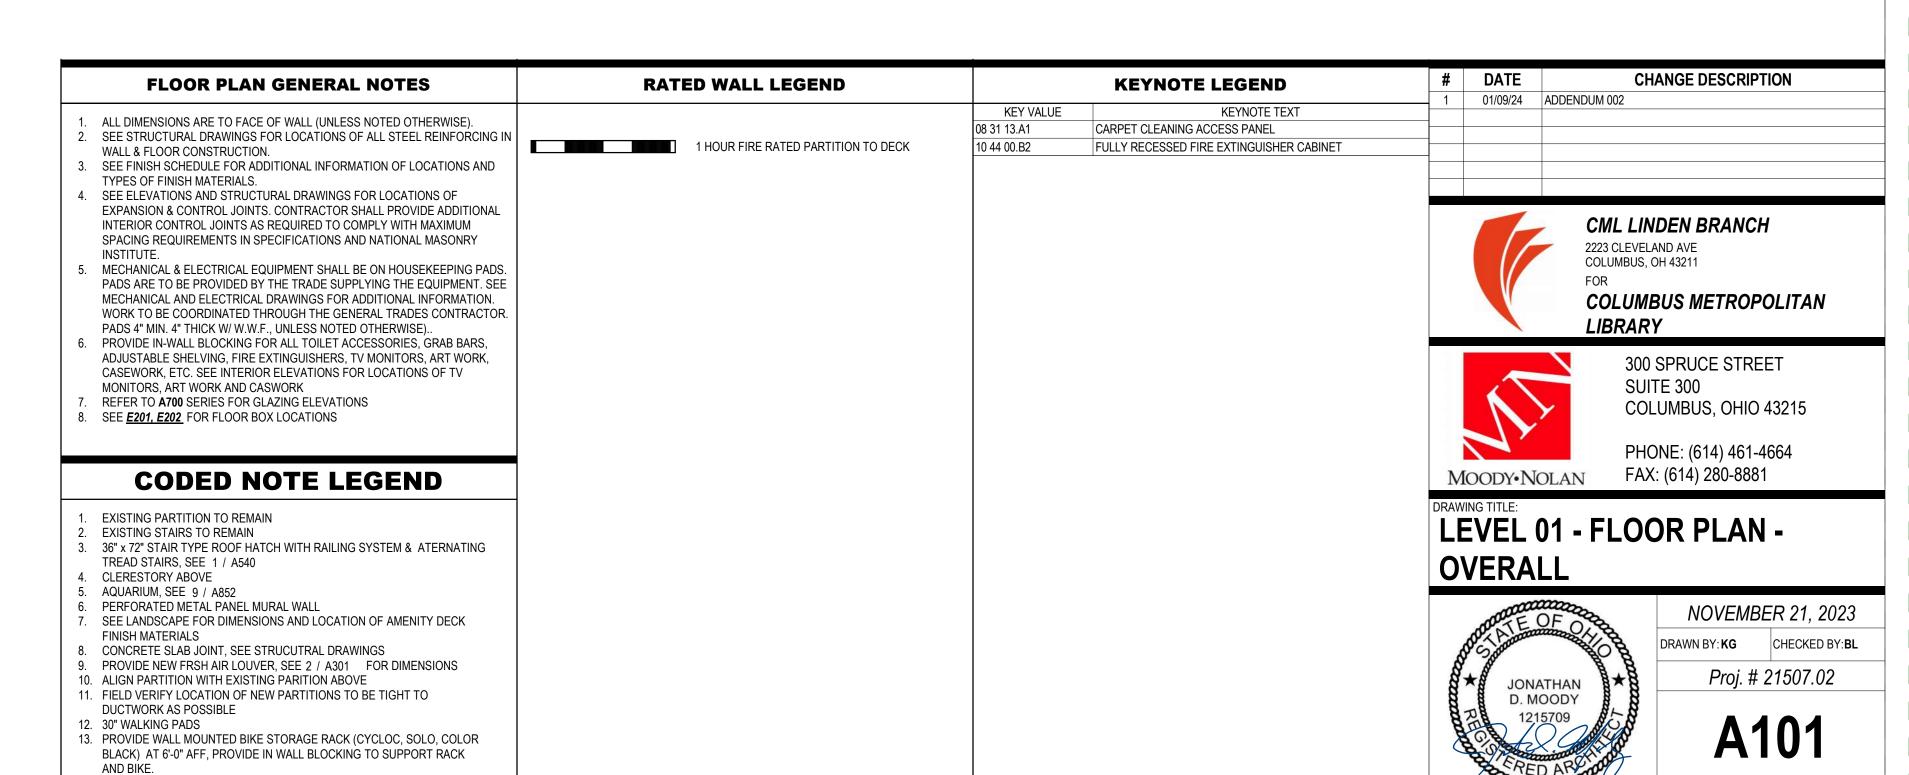



PERMIT SET

JONATHAN D. MOODY, LIC. #1215709

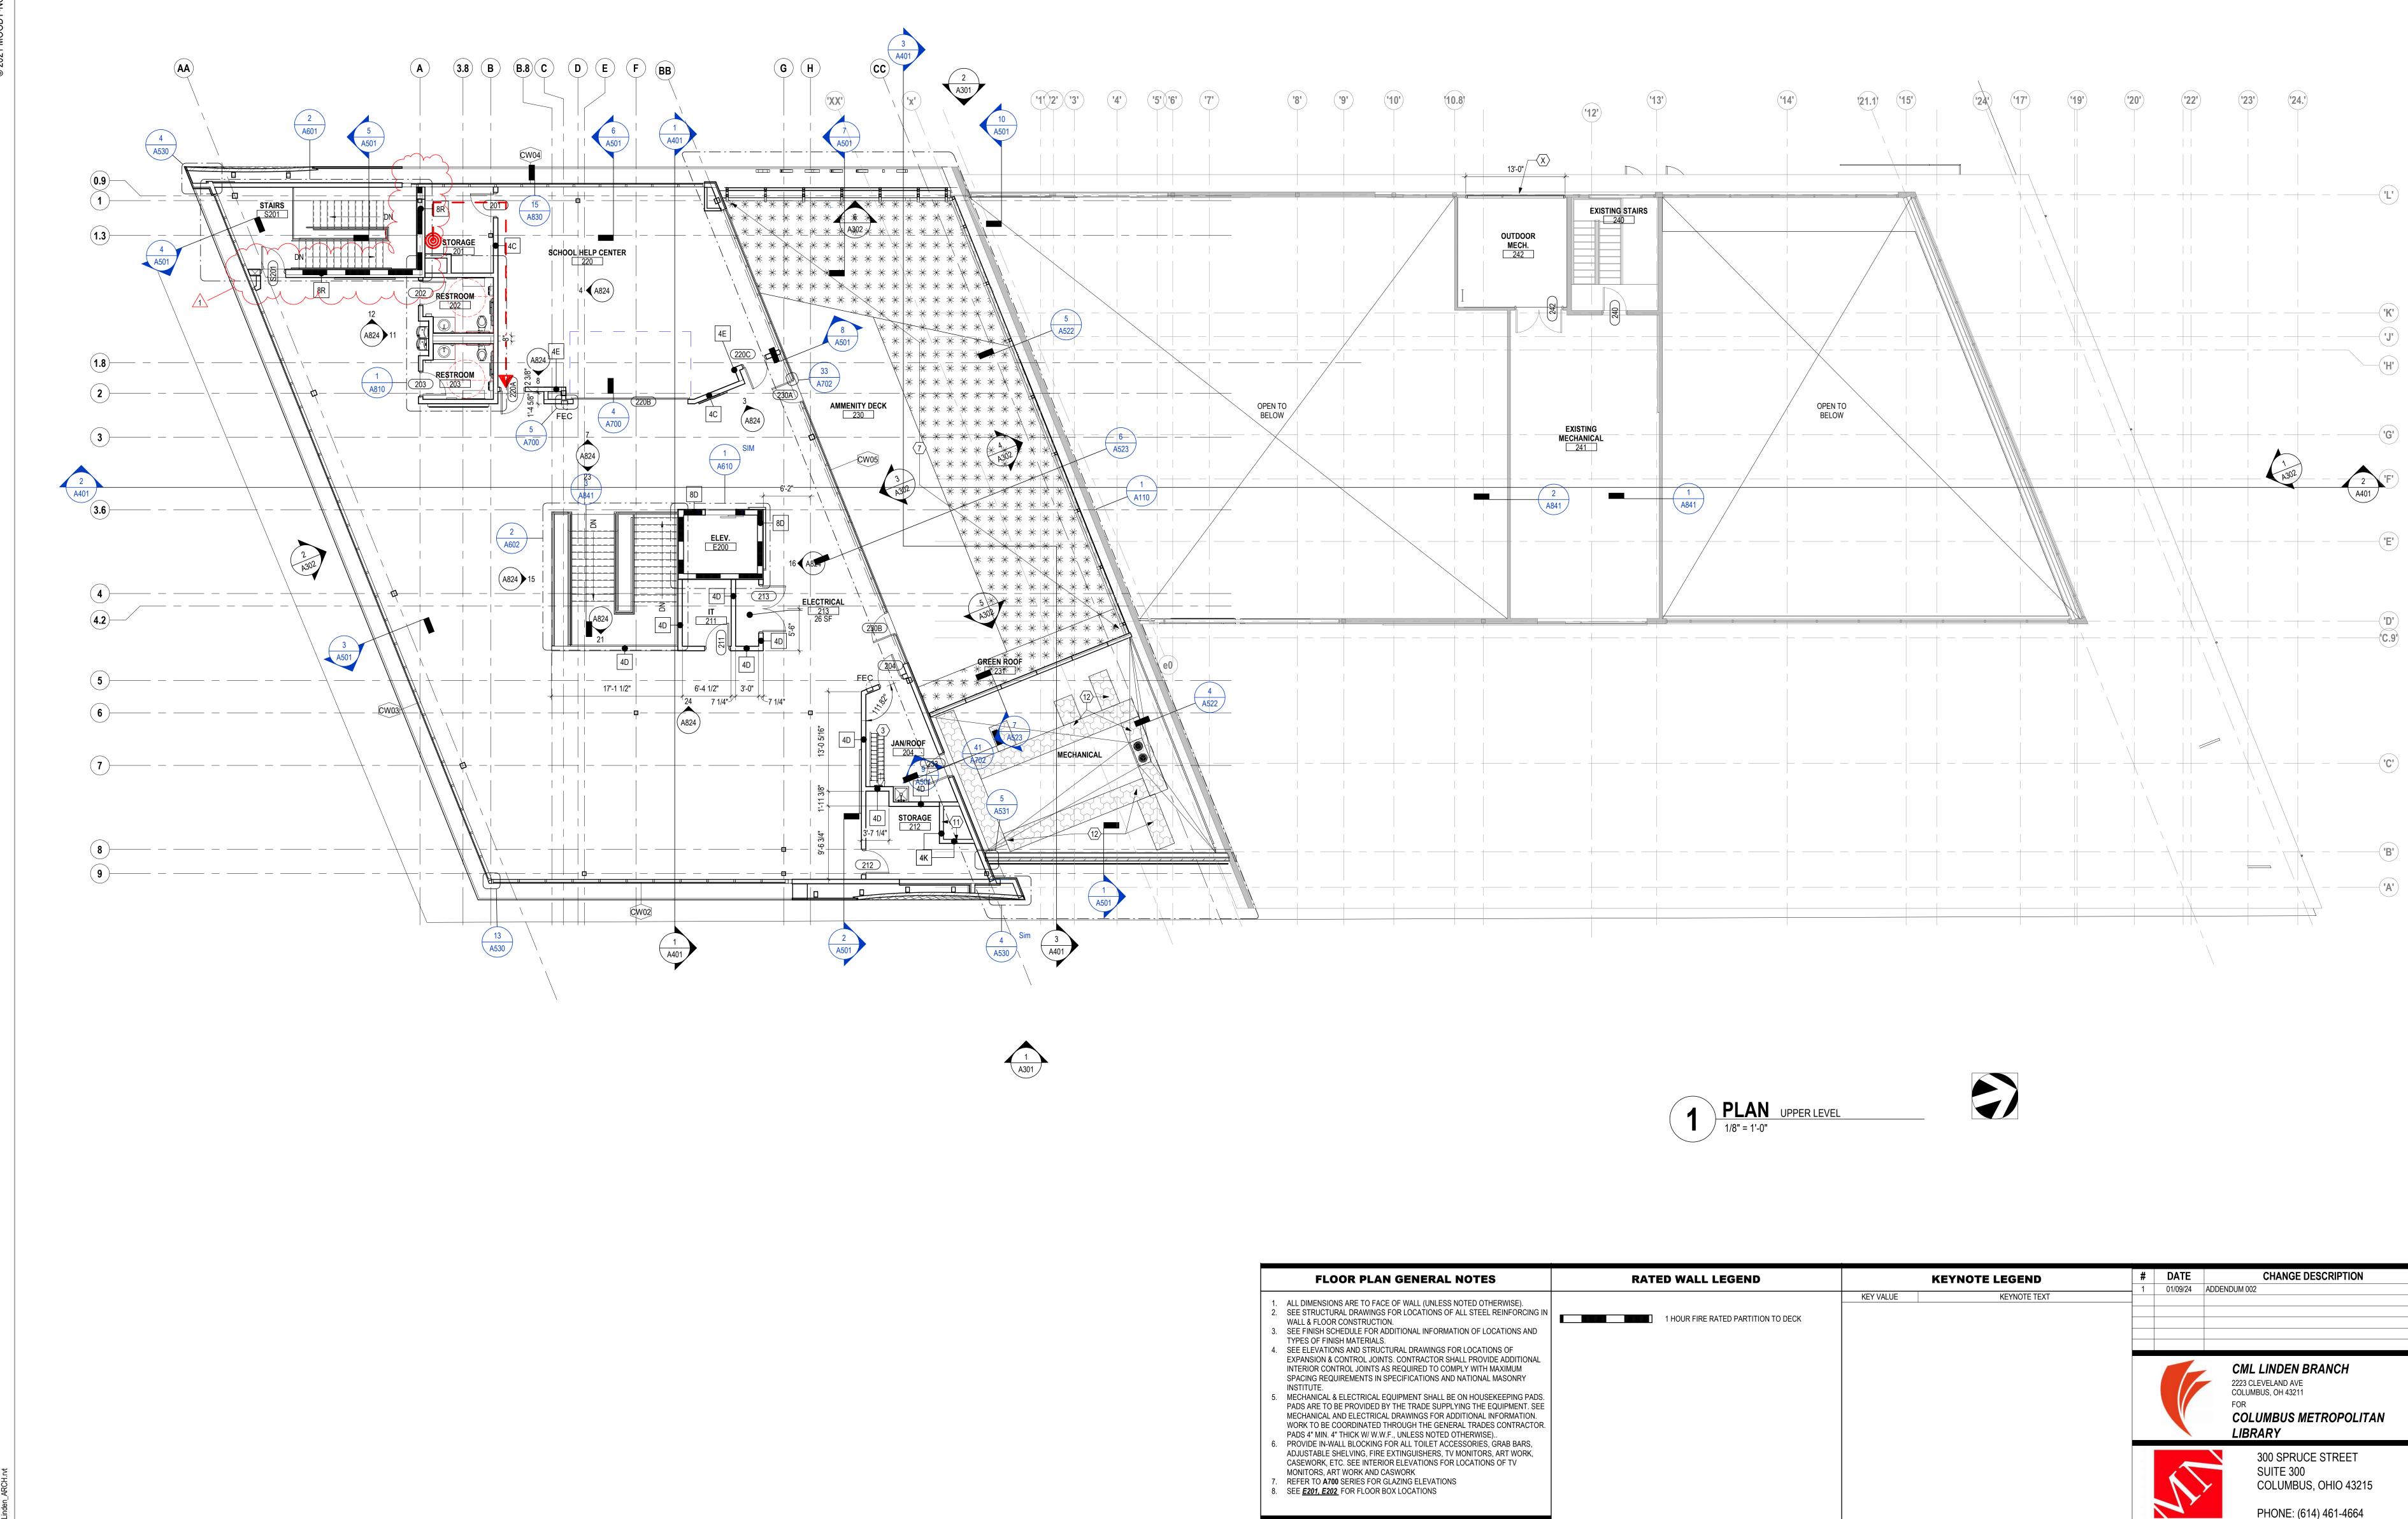


PHONE: (614) 461-4664 FAX: (614) 280-8881 CODED NOTE LEGEND MOODY•NOLAN . EXISTING PARTITION TO REMAIN LEVEL 02 - FLOOR PLAN -EXISTING STAIRS TO REMAIN 3. 36" x 72" STAIR TYPE ROOF HATCH WITH RAILING SYSTEM & ATERNATING OVERALL TREAD STAIRS, SEE 1 / A540 4. CLERESTORY ABOVE 5. AQUARIUM, SEE 9 / A852 . PERFORATED METAL PANEL MURAL WALL NOVEMBER 21, 2023 . SEE LANDSCAPE FOR DIMENSIONS AND LOCATION OF AMENITY DECK FINISH MATERIALS DRAWN BY: KG CHECKED BY:BL B. CONCRETE SLAB JOINT, SEE STRUCUTRAL DRAWINGS PROVIDE NEW FRSH AIR LOUVER, SEE 2 / A301 FOR DIMENSIONS Proj. # 21507.02 10. ALIGN PARTITION WITH EXISTING PARITION ABOVE JONATHAN D. MOODY 11. FIELD VERIFY LOCATION OF NEW PARTITIONS TO BE TIGHT TO DUCTWORK AS POSSIBLE A102 12. 30" WALKING PADS 3. PROVIDE WALL MOUNTED BIKE STORAGE RACK (CYCLOC, SOLO, COLOR BLACK) AT 6'-0" AFF, PROVIDE IN WALL BLOCKING TO SUPPORT RACK AND BIKE. PERMIT SET JONATHAN D. MOODY, LIC. #1215709

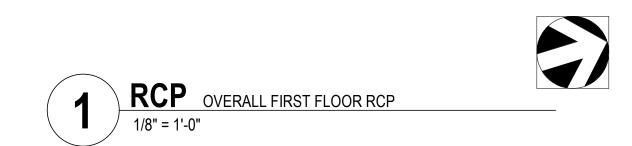

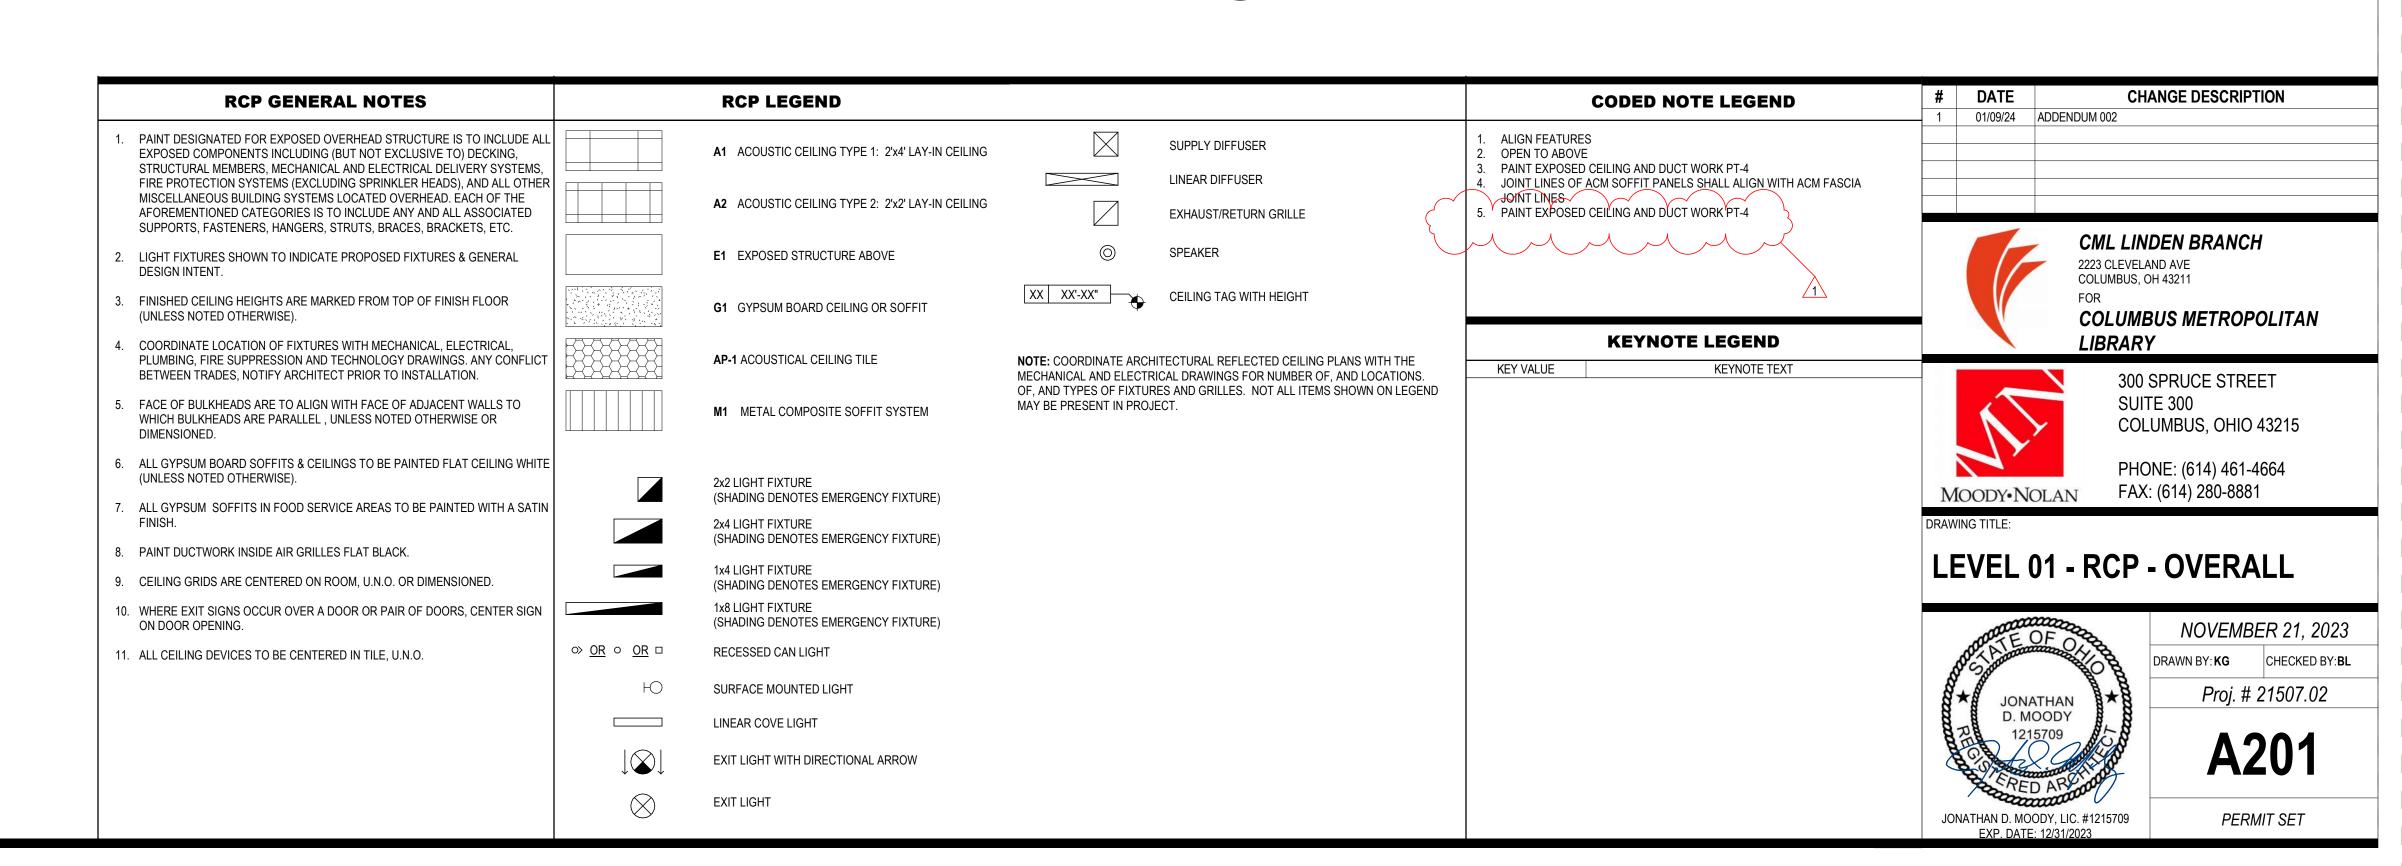

Autodesk Docs://21507 CML Linden Branch - R22/21507 CML Linden_ARCH.rvt

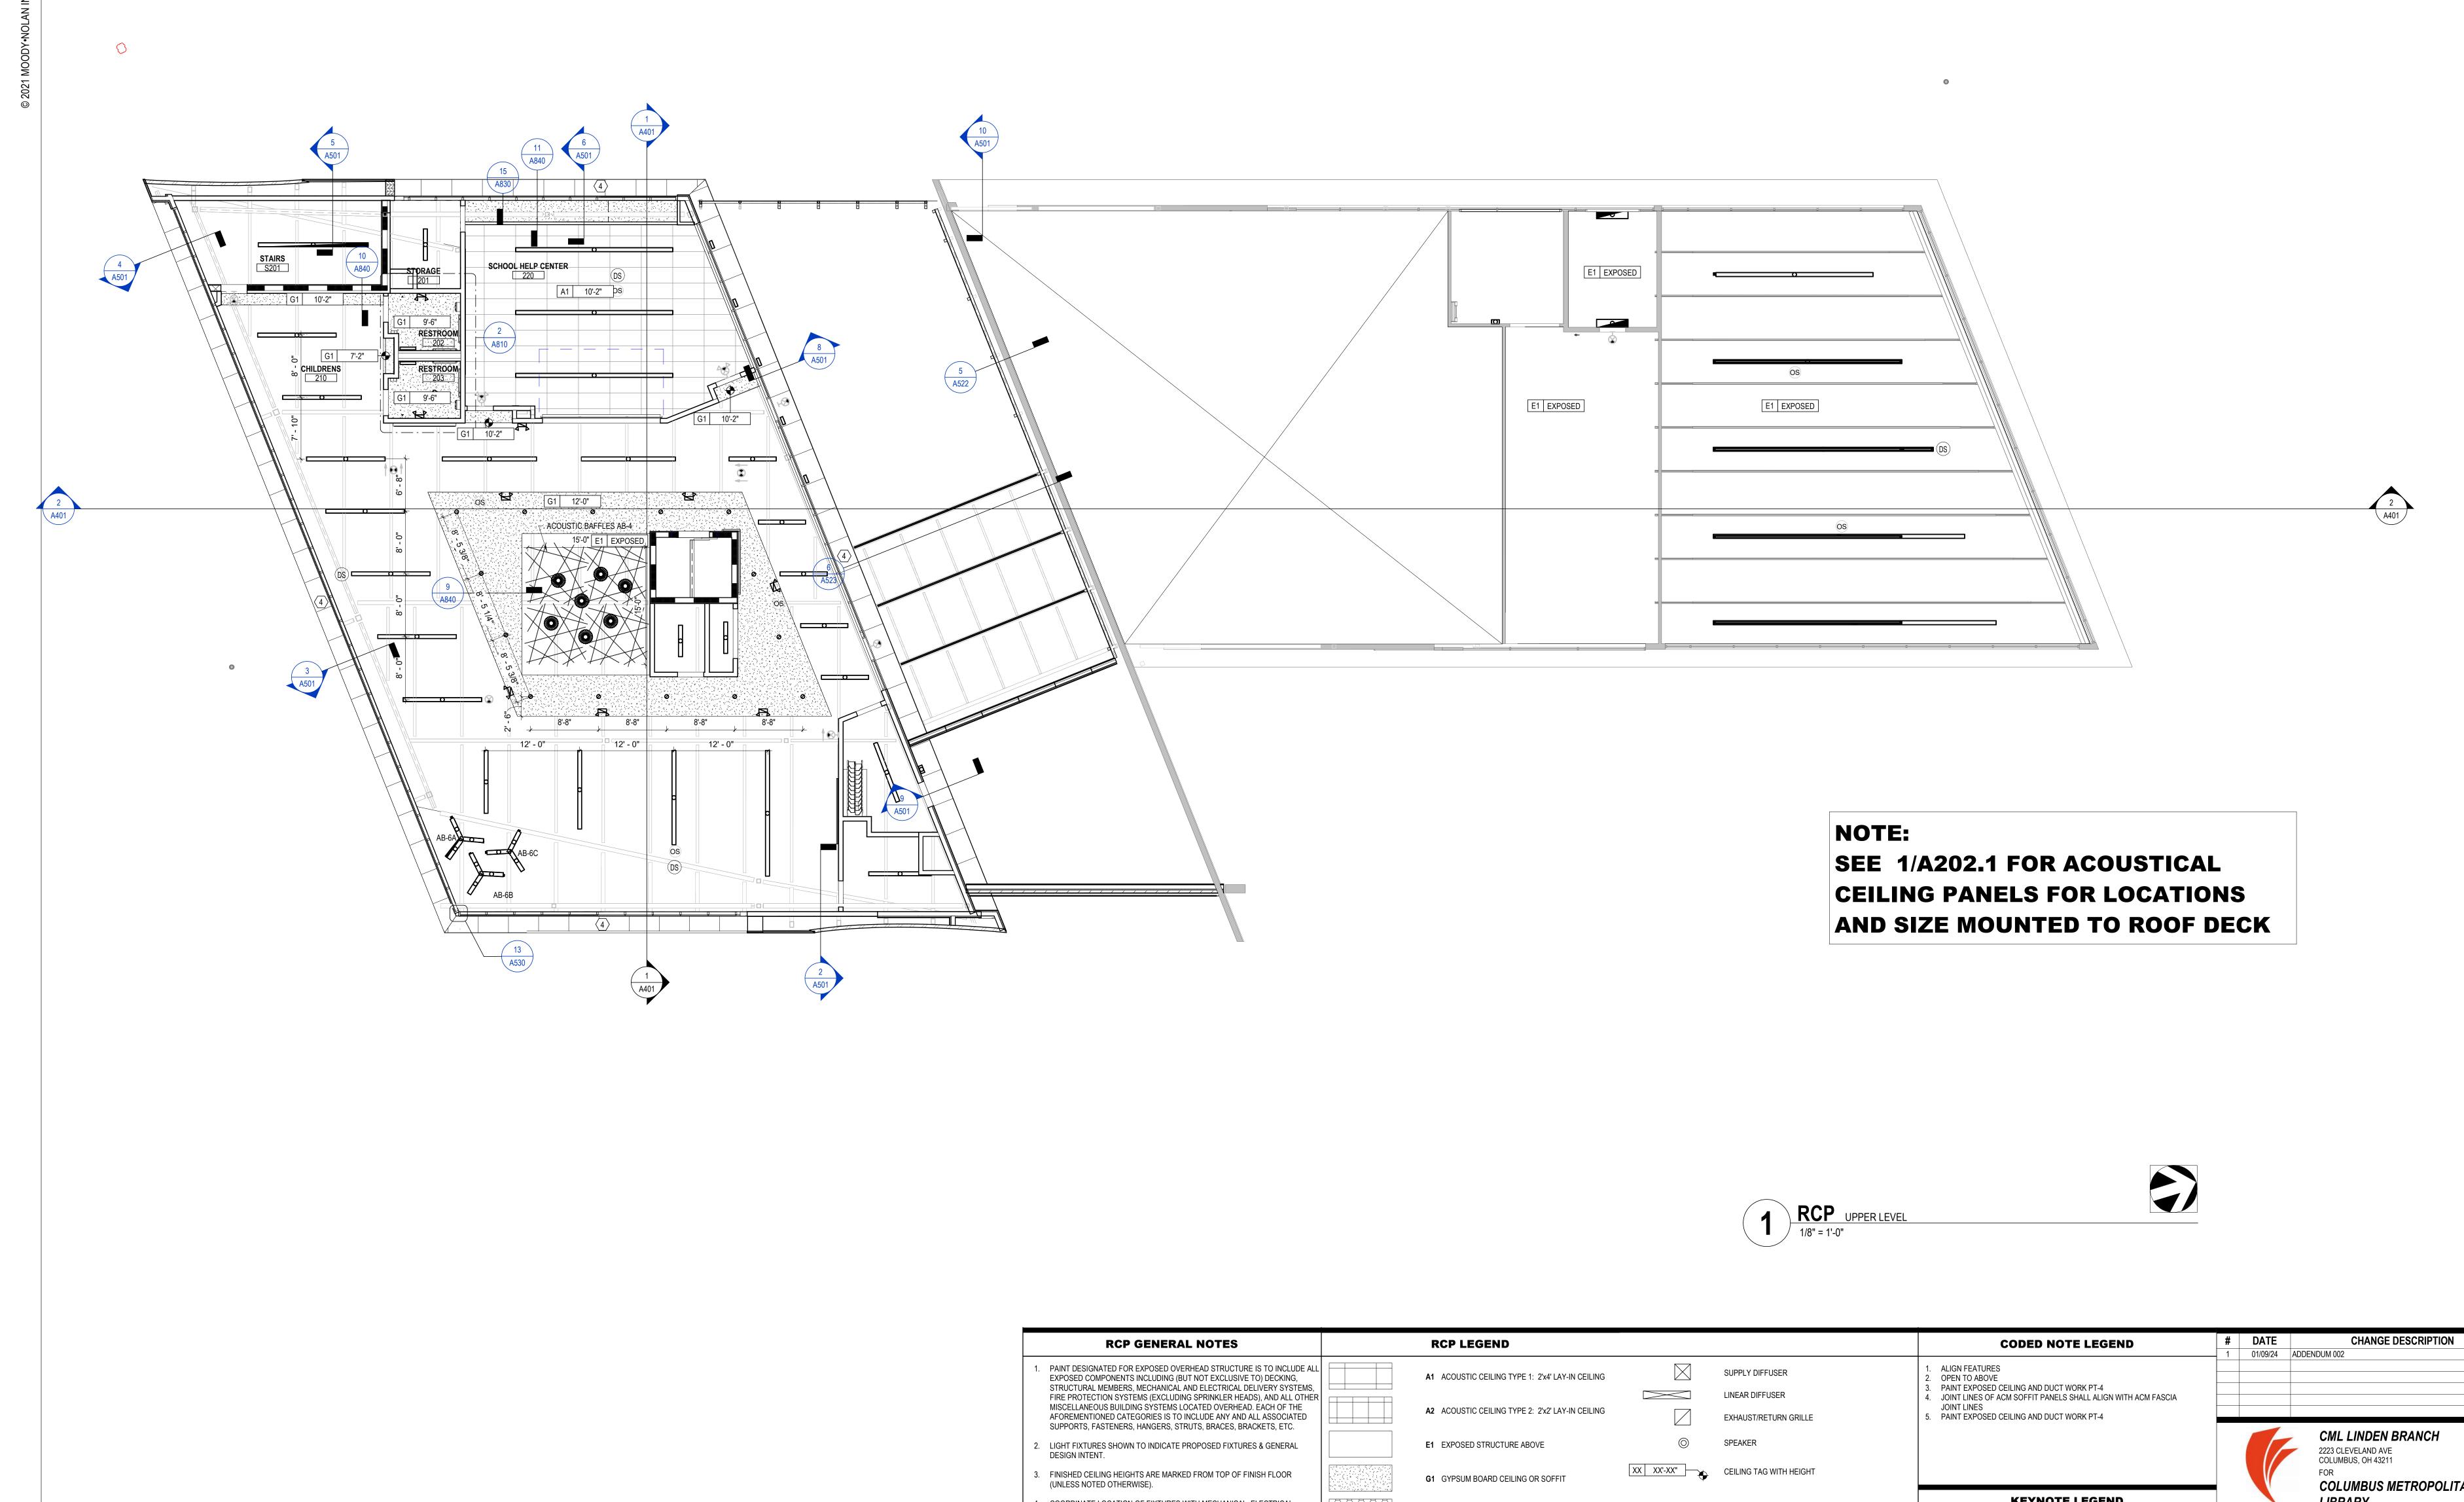

COLUMBUS METROPOLITAN LIBRARY **KEYNOTE LEGEND** COORDINATE LOCATION OF FIXTURES WITH MECHANICAL, ELECTRICAL, AP-1 ACOUSTICAL CEILING TILE PLUMBING, FIRE SUPPRESSION AND TECHNOLOGY DRAWINGS. ANY CONFLICT NOTE: COORDINATE ARCHITECTURAL REFLECTED CEILING PLANS WITH THE KEYNOTE TEXT KEY VALUE 300 SPRUCE STREET BETWEEN TRADES, NOTIFY ARCHITECT PRIOR TO INSTALLATION. MECHANICAL AND ELECTRICAL DRAWINGS FOR NUMBER OF, AND LOCATIONS. SUITE 300 FACE OF BULKHEADS ARE TO ALIGN WITH FACE OF ADJACENT WALLS TO MAY BE PRESENT IN PROJECT. M1 METAL COMPOSITE SOFFIT SYSTEM WHICH BULKHEADS ARE PARALLEL , UNLESS NOTED OTHERWISE OR COLUMBUS, OHIO 43215 DIMENSIONED. ALL GYPSUM BOARD SOFFITS & CEILINGS TO BE PAINTED FLAT CEILING WHITE PHONE: (614) 461-4664 (UNLESS NOTED OTHERWISE). 2x2 LIGHT FIXTURE FAX: (614) 280-8881 MOODY•NOLAN (SHADING DENOTES EMERGENCY FIXTURE) 7. ALL GYPSUM SOFFITS IN FOOD SERVICE AREAS TO BE PAINTED WITH A SATIN 2x4 LIGHT FIXTURE (SHADING DENOTES EMERGENCY FIXTURE) 8. PAINT DUCTWORK INSIDE AIR GRILLES FLAT BLACK. LEVEL 02 - RCP - OVERALL 1x4 LIGHT FIXTURE 9. CEILING GRIDS ARE CENTERED ON ROOM, U.N.O. OR DIMENSIONED. (SHADING DENOTES EMERGENCY FIXTURE) 10. WHERE EXIT SIGNS OCCUR OVER A DOOR OR PAIR OF DOORS, CENTER SIGN (SHADING DENOTES EMERGENCY FIXTURE) NOVEMBER 21, 2023 ON DOOR OPENING. RECESSED CAN LIGHT 11. ALL CEILING DEVICES TO BE CENTERED IN TILE, U.N.O. SURFACE MOUNTED LIGHT Proj. # 21507.02 D. MOODY LINEAR COVE LIGHT EXIT LIGHT WITH DIRECTIONAL ARROW PERMIT SET JONATHAN D. MOODY, LIC. #1215709


ABBREVIATIONS NOTE: NOT ALL ABBREVIATIONS MAY BE USED. (A) EXISTING TO BE ABANDONED (D) EXISTING TO BE DEMOLISHED (E) EXISTING TO REMAIN (F) FUTURE (R) EXISTING TO BE RELOCATED A AMPERE AC ALTERNATING CURRENT OR AIR CONDITIONER AFF ABOVE FINISHED FLOOR AFG ABOVE FINISHED GRADE AIC AMPS INTERRUPTING CAPACITY ANNC ANNUNCIATOR AWG AMERICAN WIRE GAUGE BPS BOLTED PRESSURE SWITCH C CONDUIT CB CIRCUIT BREAKER CCTV CLOSED CIRCUIT TELEVISION CKT CIRCUIT CM CONSTRUCTION MANAGER DC DIRECT CURRENT DP DISTRIBUTION PANELBOARD DTT DOUBLE TWIN TUBE EB ELECTRONIC BALLAST EC ELECTRICAL CONTRACTOR EM EMERGENCY EMT ELECTRICAL METAL TUBING EWC ELECTRIC WATER COOLER FA FIRE ALARM FLA FULL LOAD AMPS G GROUND GC GENERAL TRADES CONTRACTOR GFCI GROUND FAULT CIRCUIT INTERRUPTER GEN GENERATOR HOA HAND-OFF-AUTOMATIC HP HORSEPOWER HPC HIGH PRESSURE CONTACT SWITCH HZ HERTZ IG ISOLATED GROUND IMC INTERMEDIATE METAL CONDUIT INCD INCANDESCENT KVA KILOVOLT AMPERE KW KILOWATT LTG LIGHTING OR LIGHT LRA LOCKED ROTOR AMPS MCA MINIMUM CIRCUIT AMPACITY MCB MAIN CIRCUIT BREAKER MCC MOTOR CONTROL CENTER MDP MAIN DISTRIBUTION PANEL MLO MAIN LUGS ONLY MOCP MAXIMUM OVERCURRENT PROTECTION MSB MAIN SWITCHBOARD MH MOUNTING HEIGHT MTS MANUAL TRANSFER SWITCH NAC NOTIFICATION APPLIANCE CIRCUIT NC NORMALLY CLOSED NO NORMALLY OPEN NF NON-FUSED OCC OCCUPANCY PA PUBLIC ADDRESS PB PULL BOX OR PUSH BUTTON PVC POLYVINYL CHLORIDE (PLASTIC PIPE) PWR POWER RECPT RECEPTACLE STP SHIELDED, TWISTED PAIR TC TIME CLOCK TRT TRIPLE TUBE TYP TYPICAL UNO UNLESS NOTED OTHERWISE UTP UNSHIELDED, TWISTED PAIR V VOLT W WATT WAP WIRELESS ACCESS POINT WH WATTHOUR WP WEATHERPROOF, NEMA 3R UNO XFMR TRANSFORMER

Z IMPEDANCE □ PHASE

	SHTING SYMBOLS SYMBOLS MAY BE USED.
o o o	GENERAL PURPOSE LUMINAIRE: REFER TO LUMINAIRE SCHEDULE FOR ADDITIONAL INFORMATION
4	GENERAL PURPOSE LUMINAIRE ON EMERGENCY POWER: REFER TO LUMINAIRE SCHEDULE FOR ADDITIONAL INFORMATION
0	ROUND LUMINAIRE: REFER TO LUMINAIRE SCHEDUL FOR ADDITIONAL INFORMATION
	WALL MOUNTED : REFER TO LUMINAIRE SCHEDULE FOR ADDITIONAL INFORMATION
	TRACK LIGHTING
	TRACK LIGHTING HEAD
abla	REMOTE HEAD
	STEP LIGHT
4_4	EMERGENCY LIGHT
Ю	EXIT SIGN
⊗‡ ⊗↓	CEILING MOUNTED ILLUMINATED EXIT SIGN WITH DIRECTIONAL ARROWS
₩	EMERGENCY DUAL FACE ILLUMINATED EXIT SIGN WITH DIRECTIONAL ARROWS
\$	EXIT SIGN WITH INTEGRAL HEADS
\$ ^x	LINE VOLTAGE SWITCH: X=BLANK-SINGLE POLE 20A, TOGGLE; X=3-THREE WAY; X=4-FOUR WAY; X=P-PILOT LIGHT; X=OS-OCCUPANCY; X=OS,D-COMBO DIMMER OCCUPANCY
@	PHOTOCELL
LVX	LOW VOLTAGE SWITCH: X=1-TWO BUTTON ON/OFF; X=2-BUTTONS AS REQUIRED FOR ZONES SHOWN ON/OFF - RAISE/LOWER
⊚ ^x	CEILING MOUNTED OCCUPANCY SENSOR: X=BLANK-DUAL TECHNOLOGY; X=IR-PASSIVE INFRARED; X=US-ULTRASONIC; X=WP-EXTERIOR/EXTREME TEMP RATED
D	LOW VOLTAGE DIMMER
PP	POWER PACK
<u> </u>	JUNCTION BOX
<u> </u>	PANELBOARD
þ	LIGHTING CONTROL PANEL
Î	POLE MOUNTED LUMINAIRE (SINGLE)

POWER SYMBOLS					
NOTE: NOT ALL SYMBOLS MAY BE USED.					
NOTE. NOT AL					
⇒x	20A DUPLEX RECEPTACLE WITH COVER PLATE: X=MOUNTING HEIGHT (STANDARD = 18" TO CENTER); F=FLUSHED IN FLOOR, C= FLUSHED IN CEILING				
⊕ GFI	GFCI (GROUND FAULT CIRCUIT INTERRUPTER) TYPE RECEPTACLE:				
\Longrightarrow^{WP}	WEATHER-RESISTANT, GFCI RECEPTACLE: WITH "EXTRA DUTY" WEATHERPROOF IN-USE COVER				
*	RECEPTACLE, MOUNT AT 4" ABOVE SURFACE OR BACKSPLASH TO BOTTOM				
⊕ U	USB TYPE RECEPTACLE WITH TAMPER RESISTANT				
⊕ T	TAMPER RESISTANT RECEPTACLE				
\rightarrow	SIMPLEX RECEPTACLE				
-	QUADRUPLEX RECEPTACLE; SEE DUPLEX RECEPTACLE FOR TYPES				
\bowtie	WALL MOUNTED SPECIAL RECEPTACLE: REFER TO PLANS FOR ADDITIONAL INFORMATION				
	SURFACE MOUNTED RACEWAY				
□, X/Y/Z	STANDARD DISCONNECT SWITCH: X=CIRCUIT BREAKER SIZE, Y=NUMBER OF POLES, Z=SPECIAL DESIGNATION				
Z/Y/Z	STANDARD FUSED DISCONNECT SWITCH: X=CIRCUIT BREAKER SIZE, Y=FUSING, Z=NUMBER				
⊠ ^{X/Y}	OF POLES MOTOR STARTER: X=STARTER SIZE, Y=NUMBER OF POLES				
X/Y/Z ⊠₁	COMBINATION MOTOR STARTER/DISCONNECT SWITCH: X=STARTER SIZE, Y=FUSE SIZE, Z=NUMBER OF POLES				
(5)	MOTOR (BY OTHERS): PROVIDE POWER AS INDICATED				
М	UTILITY METER				
	FRACTIONAL HORSEPOWER MANUAL MOTOR				
\$ _{M,2}	STARTER; 2 = 2-POLE				
<u> </u>	JUNCTION BOX				
SPD	SURGE PROTECTIVE DEVICE				
] []	PANELBOARD				
FB_A	RECESSED 4-GANG FLOOR BOX (POWER ONLY) (WIREMOLD RFB4E-OG-6CTCBK SERIES OR APPROVED EQUAL) (1) DUPLEX RECEPTACLE (3) EMPTY GANGS FOR FUTURE USE				
FB _B	RECESSED 4-GANG FLOOR BOX (POWER AND DATA) (WIREMOLD RFB4E-OG-6CTCBK SERIES OR APPROVED EQUAL). (2) DUPLEX RECPTACLES (2) DATA OUTLETS				
FB℃	RECESSED 6-GANG FLOOR BOX (POWER AND DATA) (WIREMOLD RFB6-OG-FPBTCBK SERIES OR APPROVED EQUAL). (3) DUPLEX RECEPTACLES (6) DATA OUTLETS				
FB _D	RECESSED FLOOR BOX (POWER AND DATA) (WIREMOLD RFB4E-OG-6CFFTCBK SERIES OR APPROVED EQUAL). HARDWIRED FURNITURE CONNECTION COORDINATE COVER PLATE WITH ARCHITECT.				
€DA	RECESSED 6" DIA. POKE-THRU (POWER ONLY) (WIREMOLD 6ATC2BK SERIES OR APPROVED EQUAL) (1) DUPLEX RECEPTACLE (1) EMPTY GANG FOR FUTURE USE COORDINATE COVER PLATE WITH ARCHITECT.				
€В	RECESSED 6" DIA. POKE-THRU (POWER AND DATA) (WIREMOLD 6ATC2BK SERIES OR APPROVED EQUAL). (2) DUPLEX RECPTACLES (2) DATA OUTLETS COORDINATE COVER PLATE WITH ARCHITECT.				
Фc	RECESSED 8" DIA. POKE-THRU (POWER AND DATA) (WIREMOLD 8ATC2BK SERIES OR APPROVED EQUAL). (3) DUPLEX RECEPTACLES (6) DATA OUTLETS COORDINATE COVER PLATE WITH ARCHITECT.				

COORDINATE COVER PLATE WITH ARCHITECT.

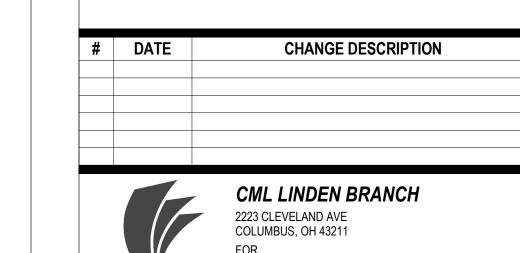



LIBRARY 300 SPRUCE STREET SUITE 300 COLUMBUS, OHIO 43215

COLUMBUS METROPOLITAN

MOODY•NOLAN

PHONE: (614) 461-4664 FAX: (614) 280-8881

DRAWING TITLE:


GENERAL INFORMATION -**ELECTRICAL**



11/21/2023 DRAWN BY: **RB** CHECKED BY: **KM** Proj. # 21507

PERMIT SET

E001

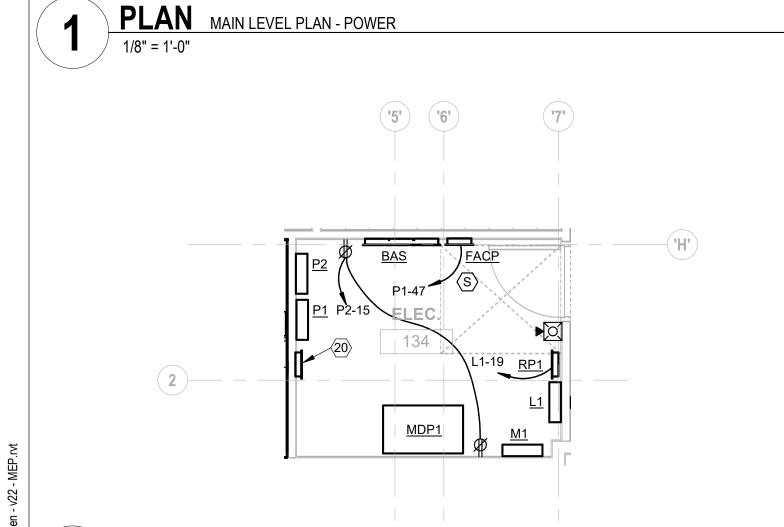

PLAN ENLARGED PLAN - ELECTRICAL 134

SHEET KEYNOTES


- ADULT CHANGING STATION. PROVIDE WALL SWITCH FOR POWER SHUT OFF, REFER TO MANUFACTURER INSTRUCTION FOR SWITCH AND ESTOP LOCATION. MAKE FINAL CONNECTIONS.
- RECEPTACLES FOR FISH TANK AUTOMATIC FEEDER AND LIGHT LOCATED IN CAVITY ABOVE TANK. REFER TO ARCHITECTURAL ELEVATIONS FOR EXACT LOCATION.
- HAND DRYER, 120V 1PH. COORDINATE MOUNTING HEIGHT WITH ARCHITECT.
- FLUSH VALVE LOW VOLTAGE TRANSFORMER POWER CONNECTION. EXTEND LOW VOLTAGE WIRING TO EACH FLUSH VALVE AND FAUCET, COORDINATE WITH PLUMBING
- POWER CONNECTION FOR AUTOMATIC FAUCET.
- RECEPTACLES MOUNTED IN CASEWORK.
- PROVIDE POWER CONNECTION TO AUTOMATIC DOOR OPERATOR. MAKE FINAL CONNECTIONS au d = 0
- JUNCTION BOX FOR POWER CONNECTION TO ROOM SCHEDULER. PROVIDE 1/2" CONDUIT STUBBED UP 3" ABOVE ACCESSIBLE CEILING.
- 9. OVERHEAD DOOR OPERATOR. SIDE MOUNT ON WALL AT 120" A.F.F.. PROVIDE LOW VOLTAGE CABLE WITH #24 AWG MINIMUM IN 1/2" CONDUIT TO SAFETY SENSORS AT LOWER EDGES OF DOOR. REFER TO ARCHITECTURAL SPECIFICATIONS FOR ADDITIONAL REQUIREMENTS.
- 10. WALL MOUNTED OVERHEAD DOOR CONTROLLER PROVIDED BY DOOR SUPPLIER AND INSTALLED BY E.C. MAKE FINAL CONNECTIONS TO DOOR OPERATOR.
- 11. PROVIDE POWER CONNECTION TO MOTORIZED MOVABLE PARTITION (208V, 3PH) AND CONTROLS. MAKE FINAL CONNECTIONS TO CONTROLS AS INDICATED IN CODED NOTES 12 AND 13. FIELD VERIFY EXACT REQUIREMENTS WITH VENDOR PRIOR TO ROUGH-IN.
- 12. PUSH BUTTON SWITCH FOR MOTORIZED MOVABLE PARTITION FOR SAFETY OPERATIONS.
- 13. KEY SWITCH FOR MOTORIZED MOVABLE PARTITION TO ACTIVATE THE SYSTEM. MOUNT AT 42" A.F.F. NEXT TO PUSH BUTTON SWITCH AS INDICATED IN CODED NOTE 12.
- 14. POWER CONNECTION FOR ANTI THEFT AND PEOPLE COUNTING DEVICES.
- 15. JUNCTION BOX FOR POWER CONNECTION TO DOOR HARDWARE POWER SUPPLY.
- 16. PROVIDE POWER CONNECTION TO MOTORIZED SHADE AND WIRE TO SWITCH (BY SHADE MANUFACTURER). PROVIDE #18 AWG TWISTED PAIR CONDUCTORS TO BAS PANEL SYSTEM/LOCAL CONTROL AS REQUIRED. COORDINATE SWITCH LOCATIONS WITH OWNER PRIOR TO ROUGH-IN.
- 17. RECEPTACLE FOR PROJECTOR AND PROJECTOR SCREEN. COORDINATE MOUNTING HEIGHT/LOCATION WITH OWNER PRIOR TO ROUGH-IN.
- 18. CIRCUIT TO GFI BREAKER.
- 19. BIPOLAR IONIZATION 208V 1P 14W.


SHEET KEYNOTES

- 20. PROVIDE CONTACTOR PANEL FOR BAS CONTROL OF EXTERIOR BUILDING MOUNTED RECEPTACLES. (4 POLE, ELECTRICALLY HELD, 24V COIL). RECEPTACLES SHALL BE TURNED OFF AT END OF
- OWNER PROVIDED PV ARRAY E-STOP BUTTON. LOCATE BOX NEXT TO UTILITY METER. EXTEND 0.75" CONDUIT, CONCEALED WITHIN BUILDING EXTERIOR WALLS, AND INTERIOR CEILINGS/PARTITIONS, UP
- TO ROOF MOUNTED PV INVERTER. E-STOP SHALL BE UTILIZED FOR PV SYSTEM RAPID SHUTDOWN.

GENERAL SHEET NOTES

- ALL RECEPTACLES LOCATED WITHIN GENERAL PUBLIC ACCESS SHALL BE TAMPER RESISTANT TYPE. COORDINATE ALL ROUGH-IN REQUIREMENTS AND EQUIPMENT LOCATIONS WITH ARCHITECTURAL DRAWINGS AND SPECIFICATIONS.
- UNLESS NOTED OTHERWISE, ALL CABLING SHALL BE IN CONDUIT ROUTED PARALLEL AND TIGHT TO BUILDING STRUCTURE.
- PROVIDE FINAL CONNECTIONS TO ALL EQUIPMENT SHOWN PER MANUFACTURER'S PUBLISHED
- ALL EXTERIOR CONNECTIONS AND DEVICES SHALL BE LISTED WEATHER RESISTANT AND WATER
- COORDINATE DEVICE COLOR SELECTIONS WITH ARCHITECT/OWNER.

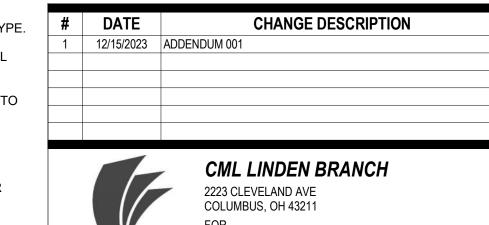

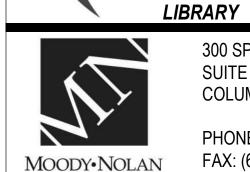

300 SPRUCE STREET SUITE 300 COLUMBUS, OHIO 43215


COLUMBUS METROPOLITAN

PHONE: (614) 461-4664 FAX: (614) 280-8881

MAIN LEVEL PLAN - POWER



11/21/2023 DRAWN BY: **RB** CHECKED BY: **KM** Proj. # 21507 **E201**

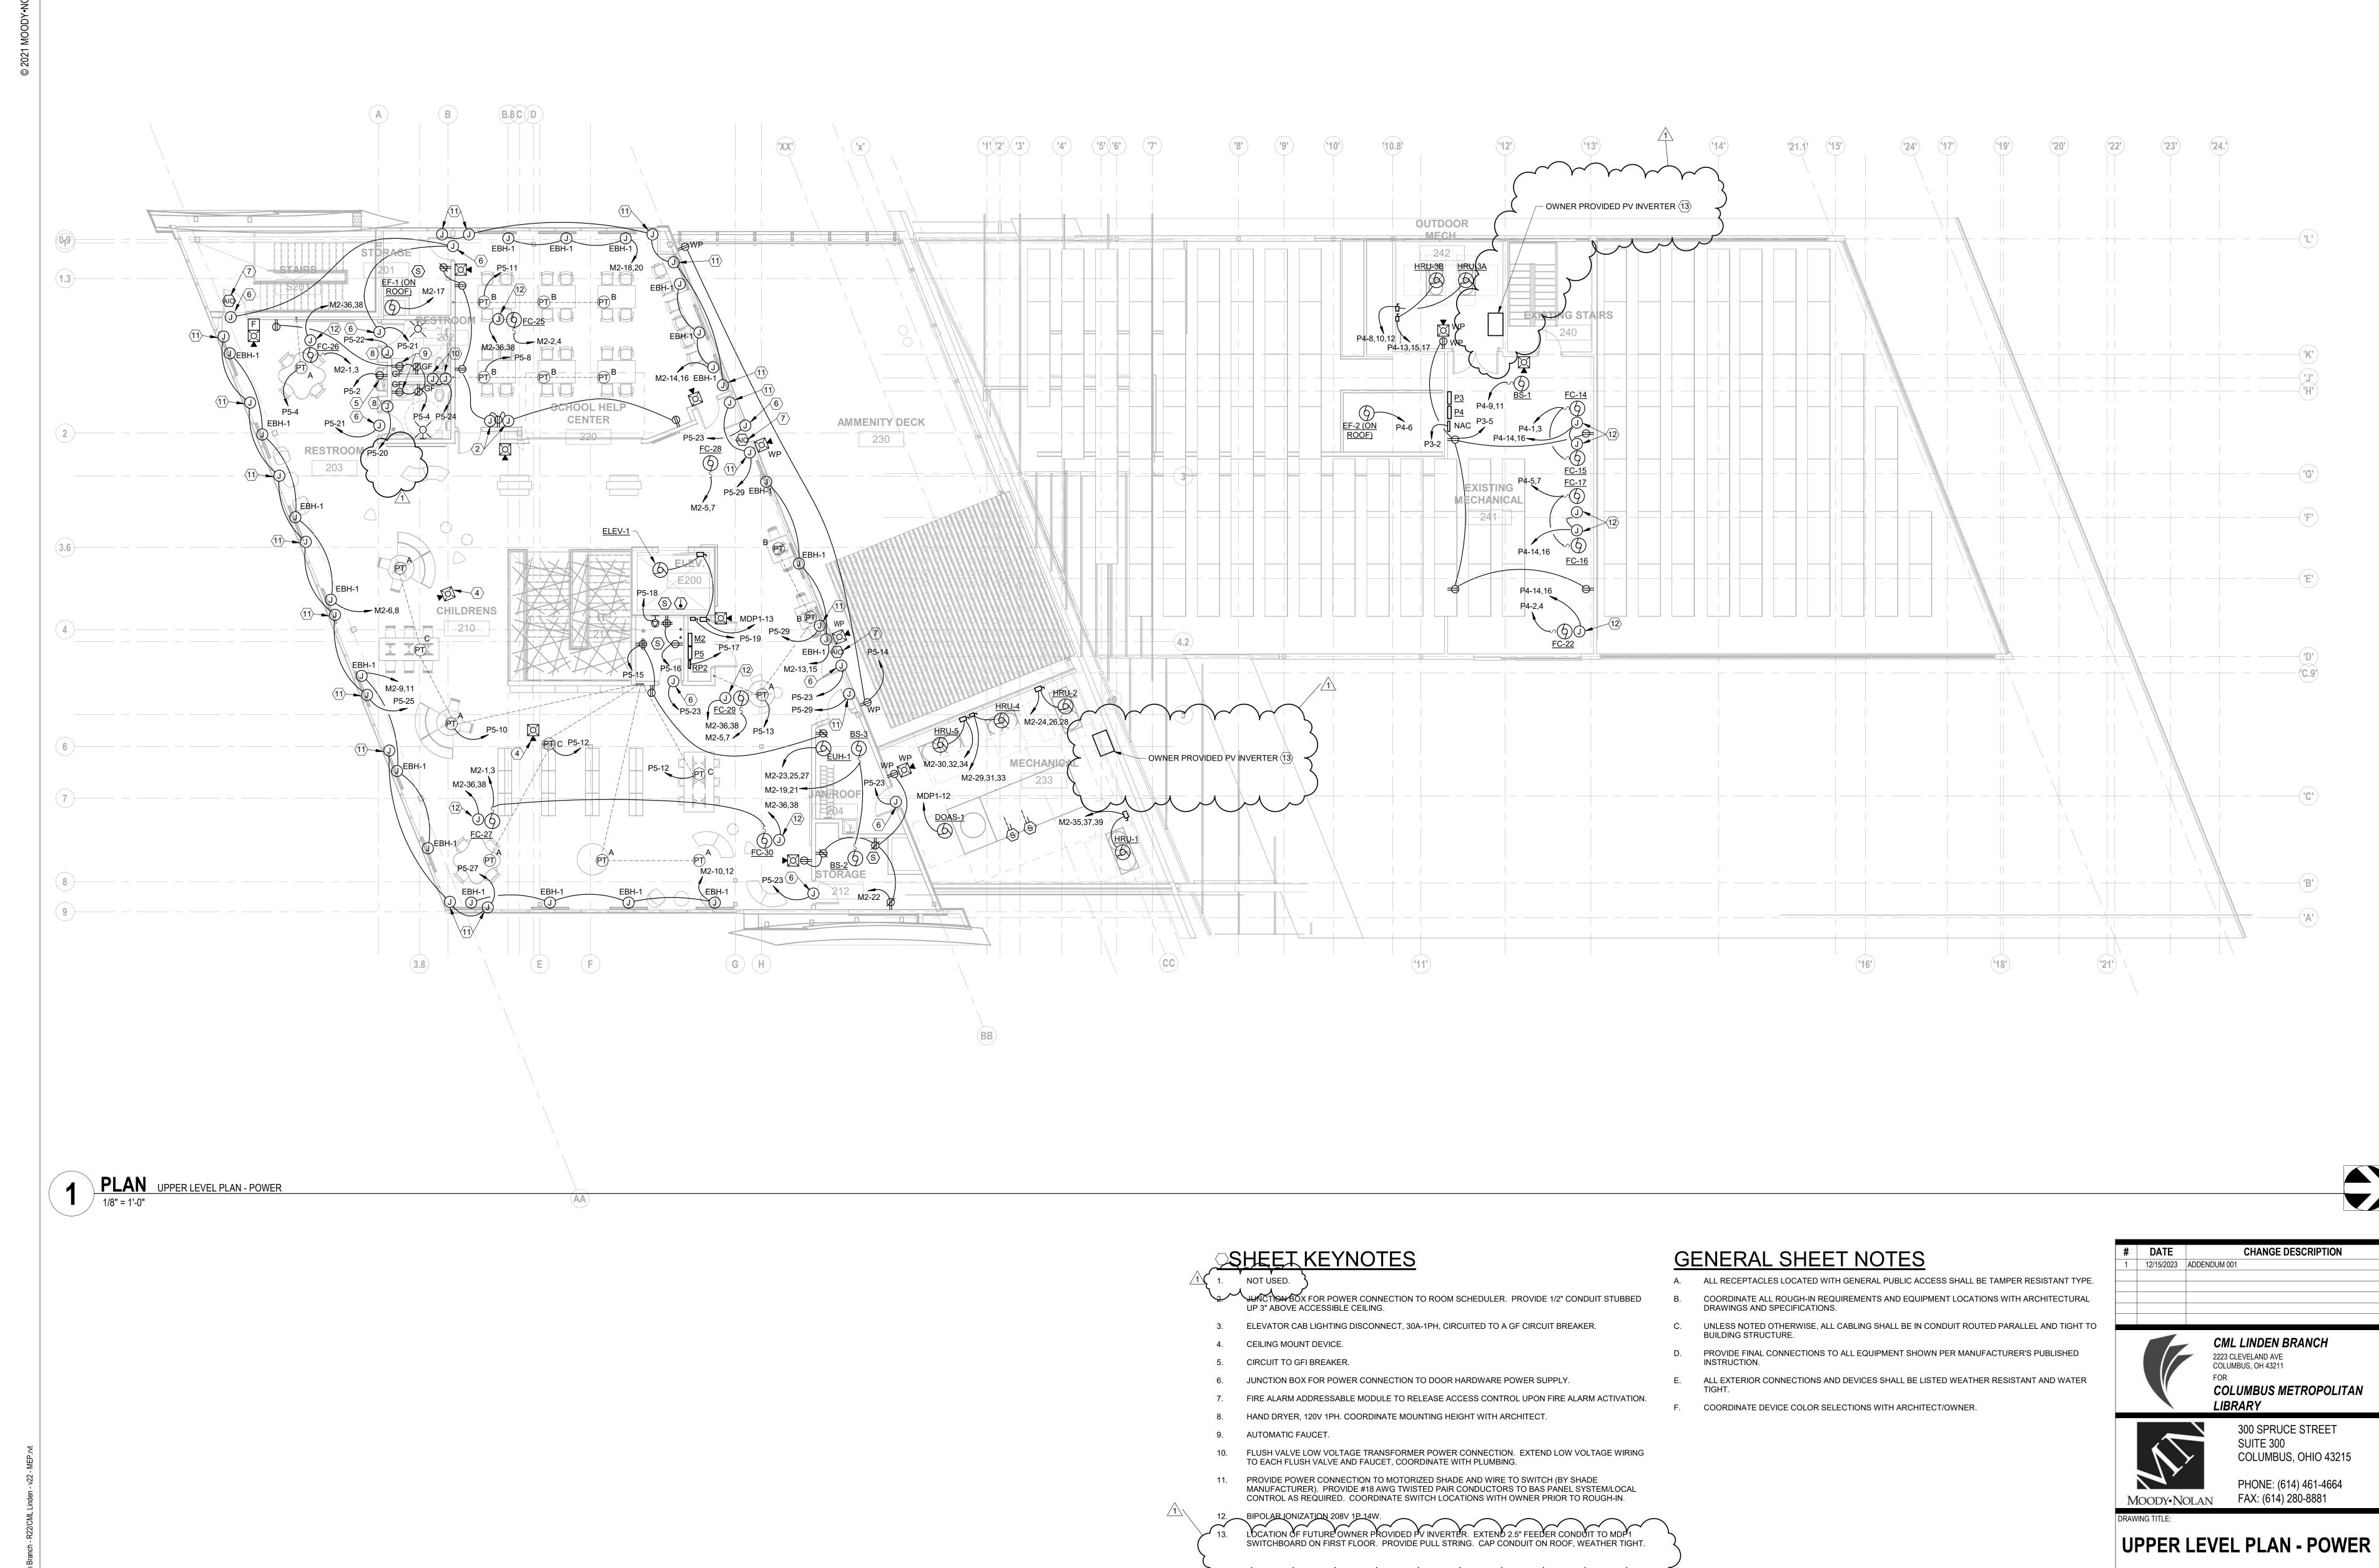

11/21/2023 11/20/2023 DRAWN BY: **RB** CHECKED BY:**KM** Proj. # 21507 JOHNATHAN S. *

SAIGE
E-82841

E-82841

E202